



Basepoint Business Centre Stroudley Road, Basingstoke Hampshire, RG24 8UP, UK Tel: 00 44 1256406664


Glenora Wind Farm 110kV Grid Connection

- All proposed routes shown are for EIAR screening only at this
- Path of cable route and location of associated Joint Bays, Link Boxes and Comms Chambers may vary depending on site
- Other services mat be encountered along the

F04	01.11.23	Issued for Information
F03	27.06.23	Issued for Information
F02	01.07.22	Issued for Information
F01	03.06.21	Issued for Information
F00	13.05.21	Issued for Information
I/R	DATE	DESCRIPTION

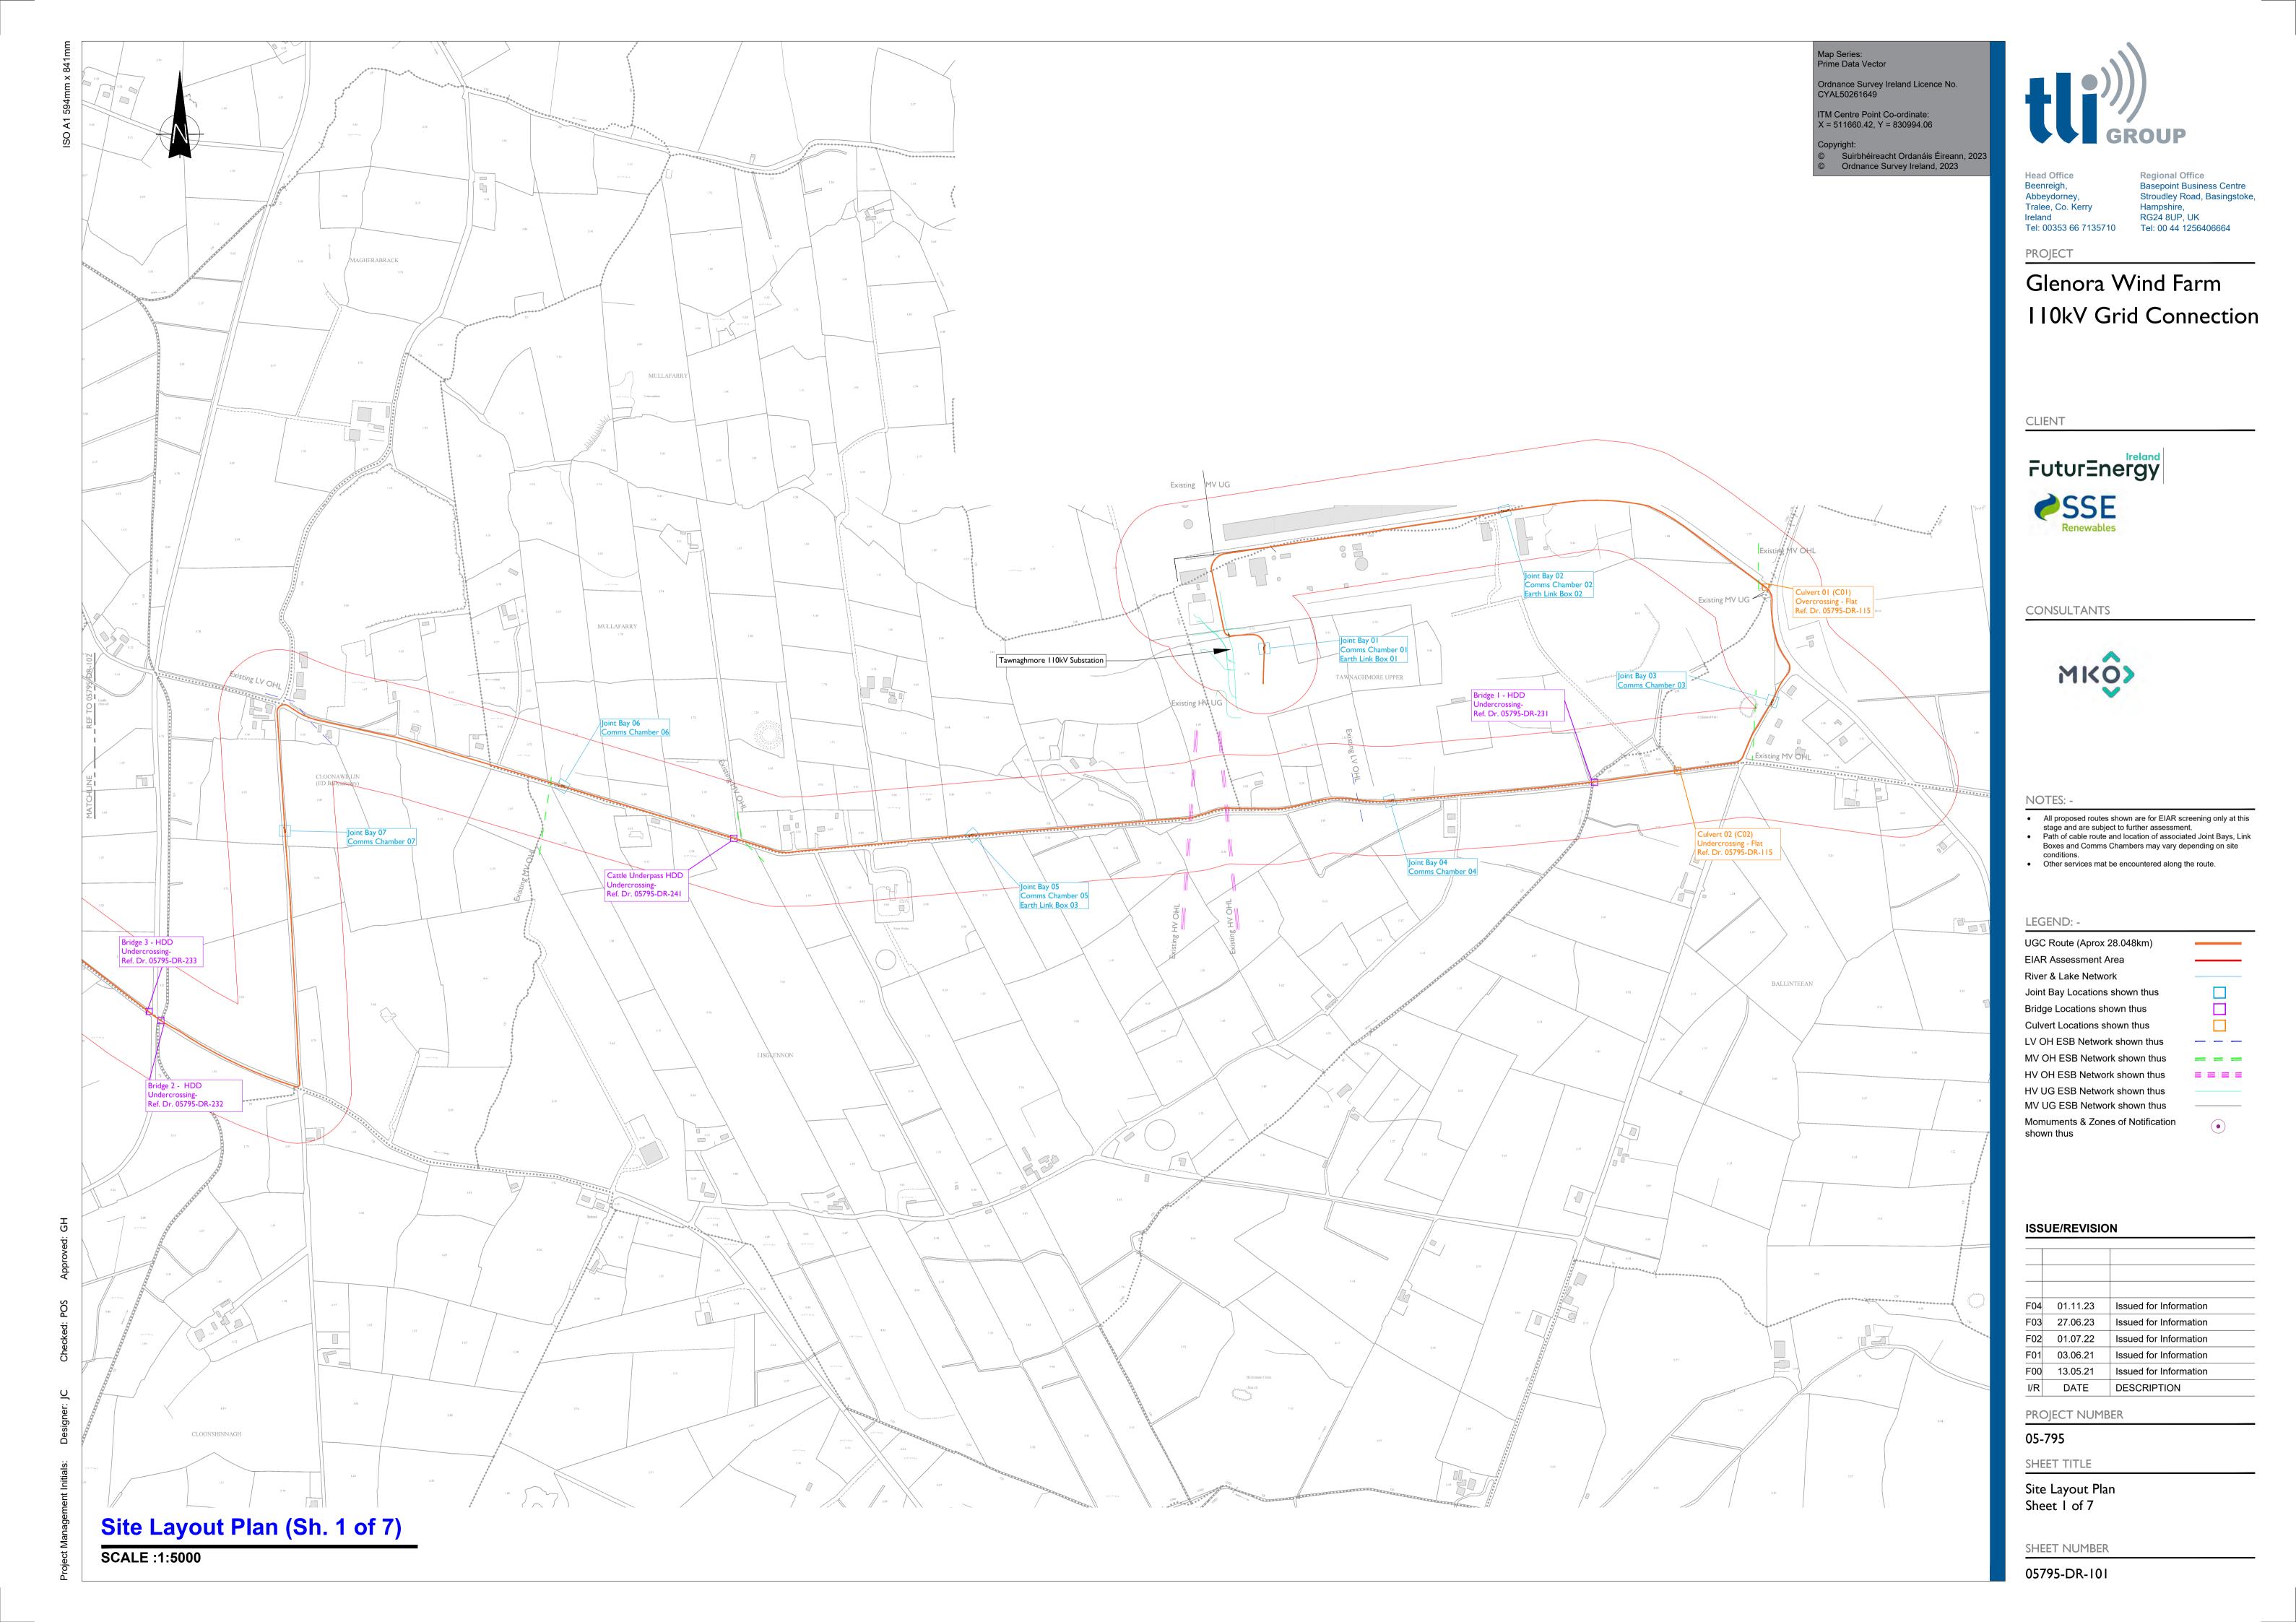

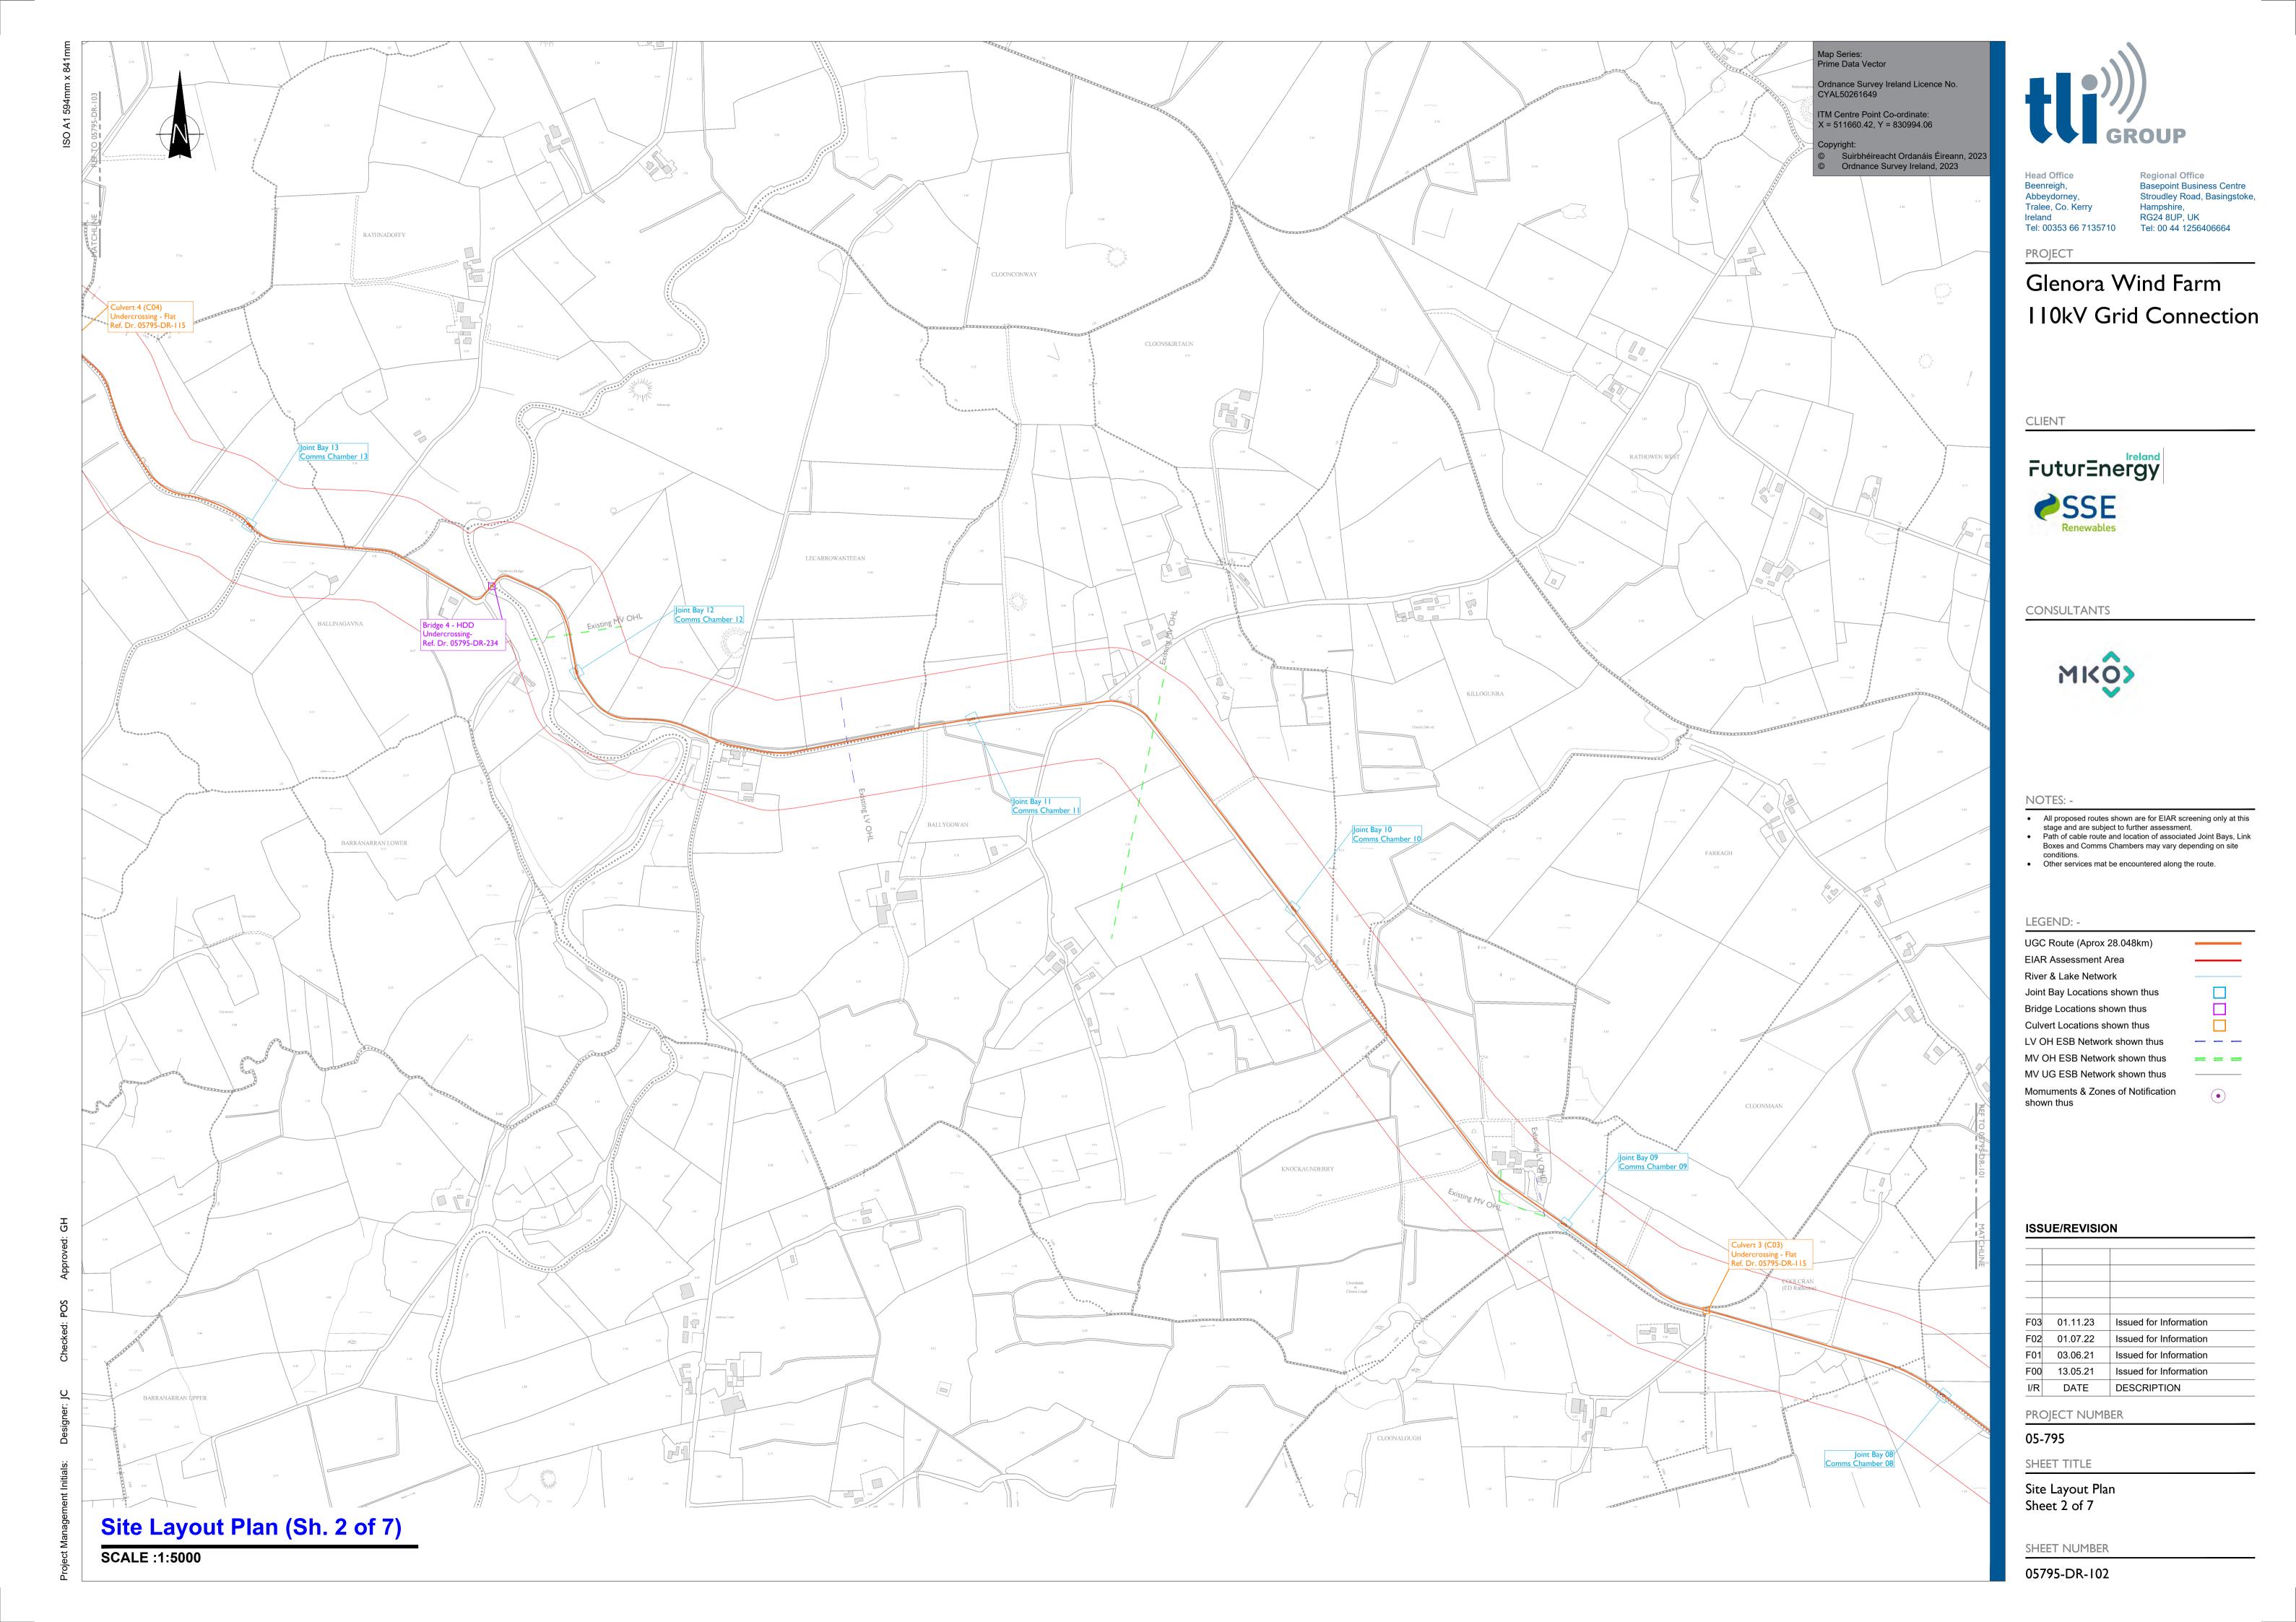

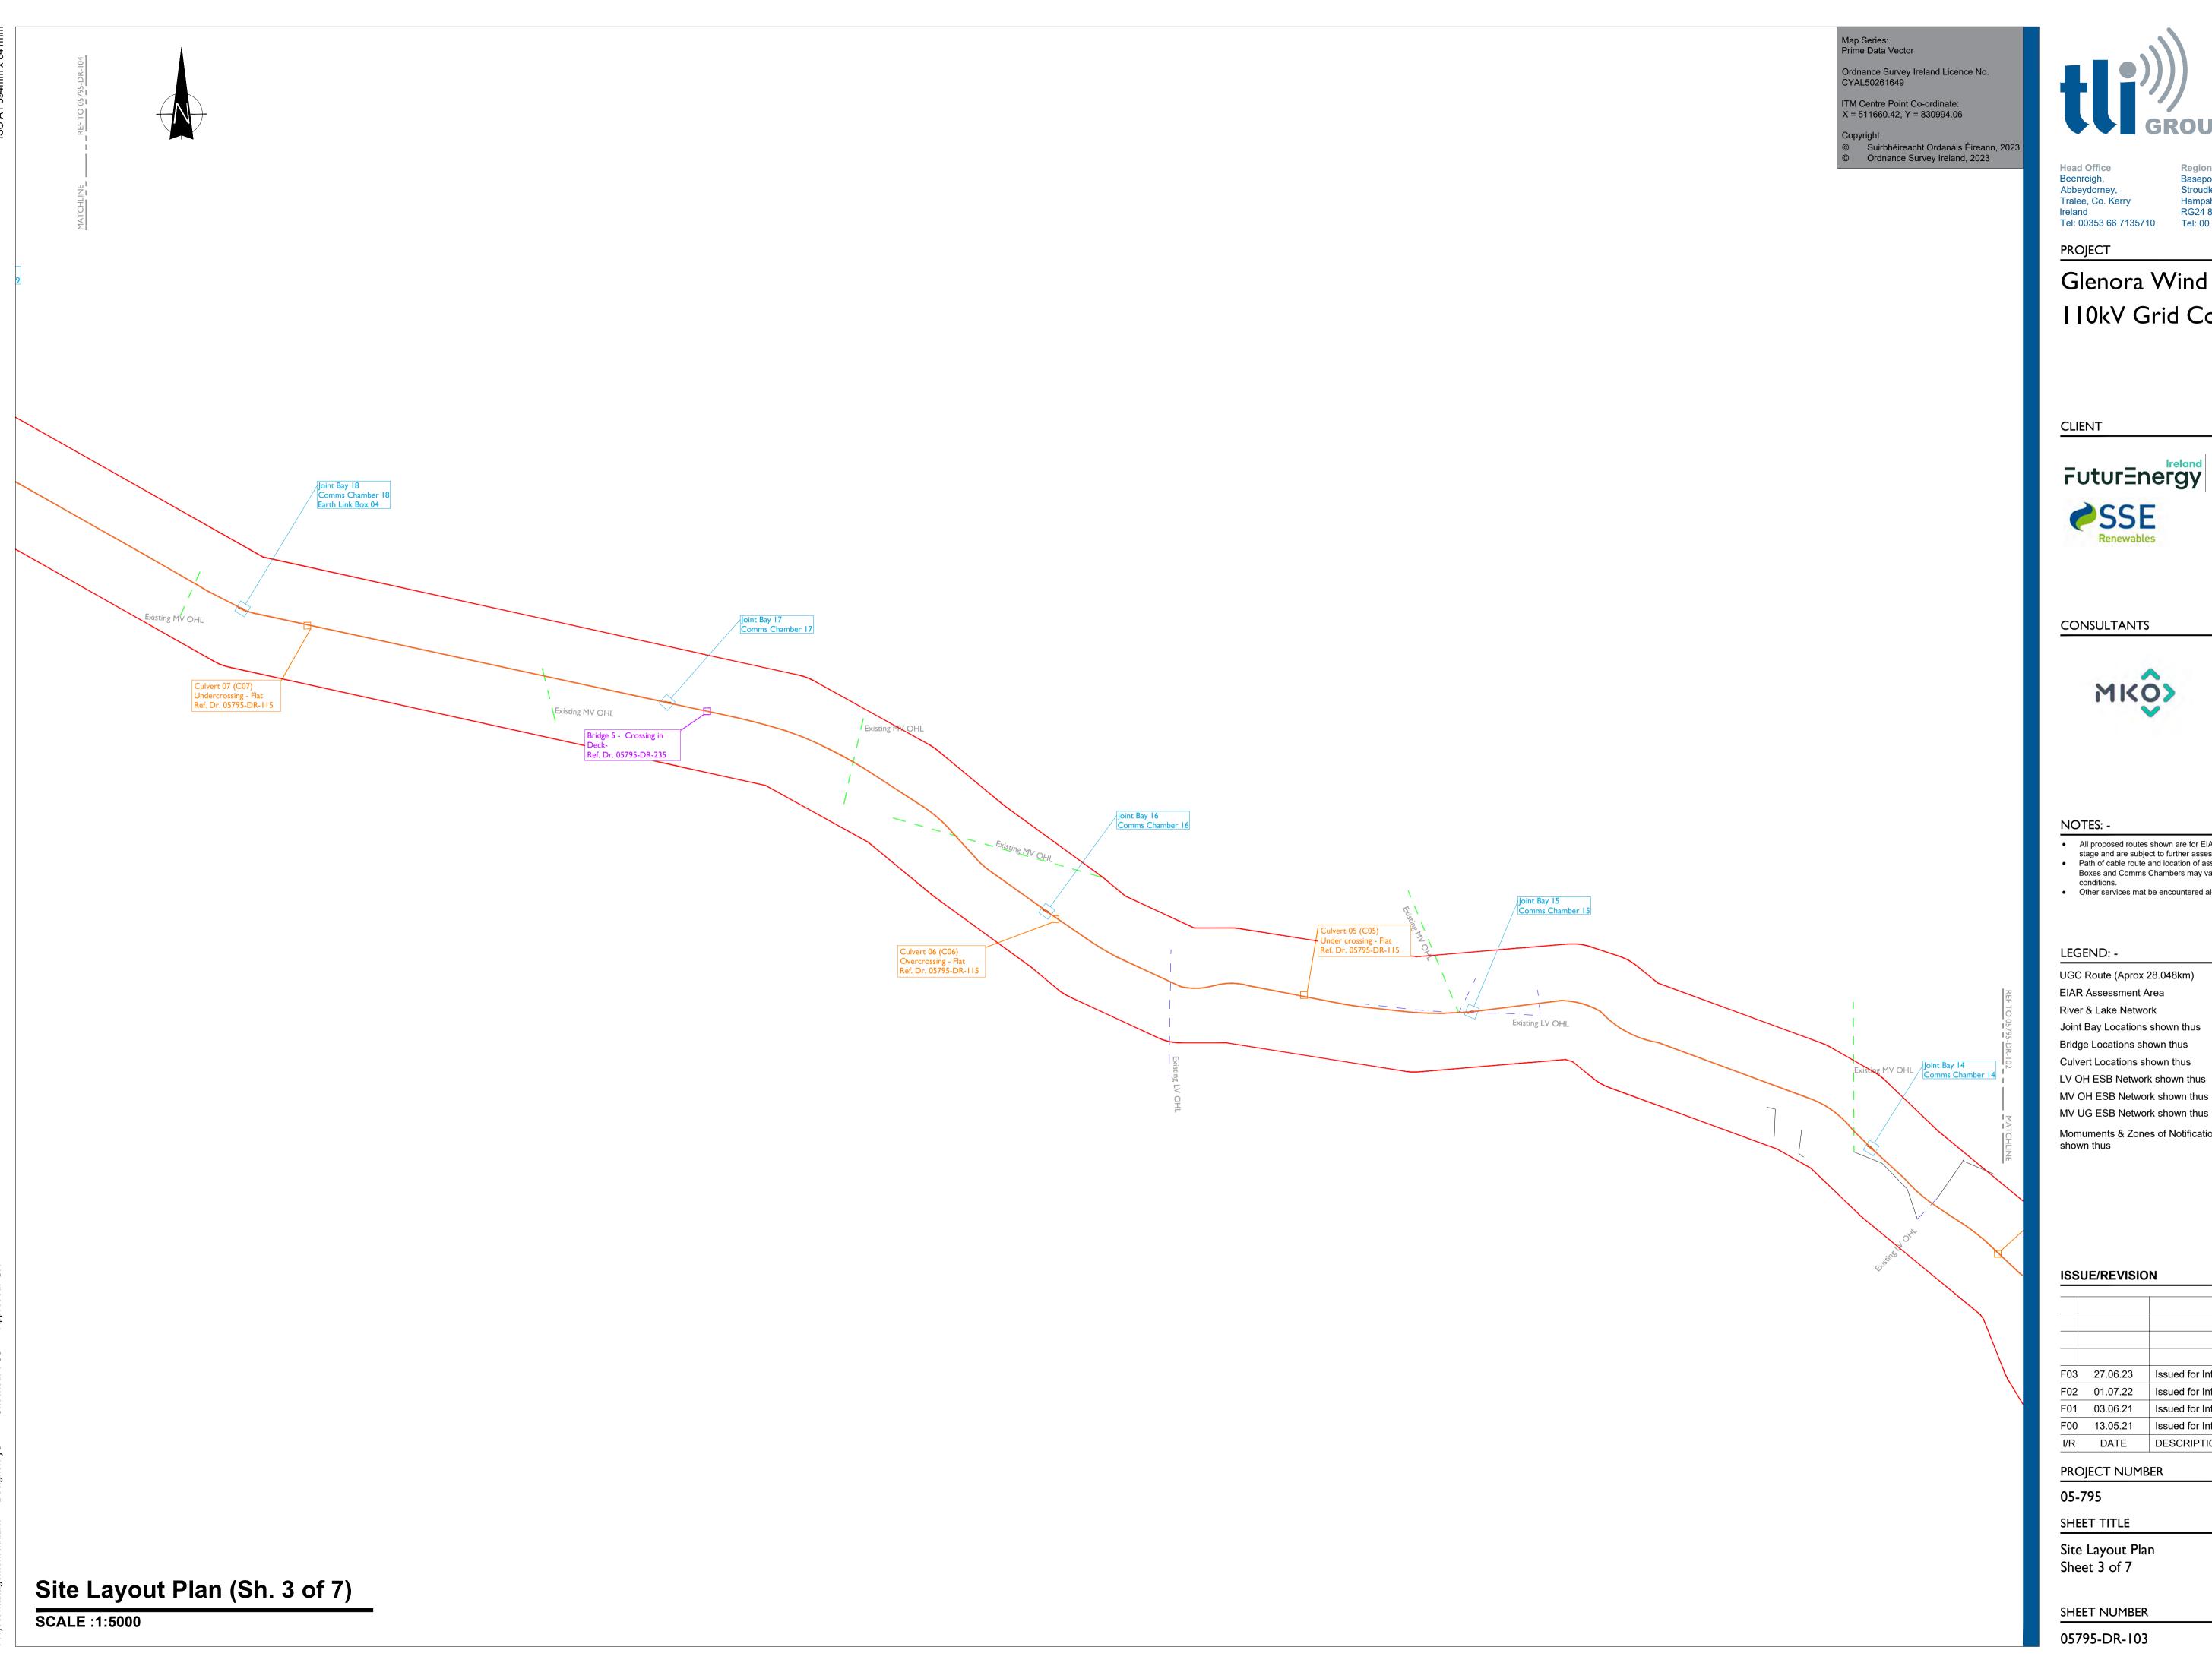



Regional Office Basepoint Business Centre Stroudley Road, Basingstoke, Hampshire, Ireland RG24 8UP, UK
Tel: 00353 66 7135710 Tel: 00 44 1256406664

Glenora Wind Farm 110kV Grid Connection





- All proposed routes shown are for EIAR screening only at this stage and are subject to further assessment.

 Path of cable route and location of associated Joint Bays, Link
- Boxes and Comms Chambers may vary depending on site
- Other services mat be encountered along the route.


UGC Route (Aprox 28.048km) EIAR Assessment Area River & Lake Network Joint Bay Locations shown thus Bridge Locations shown thus Culvert Locations shown thus LV OH ESB Network shown thus MV OH ESB Network shown thus


Momuments & Zones of Notification


F03	27.06.23	Issued for Information
F02	01.07.22	Issued for Information
F01	03.06.21	Issued for Information
F00	13.05.21	Issued for Information
I/R	DATE	DESCRIPTION


Site Layout Plan

SHEET NUMBER

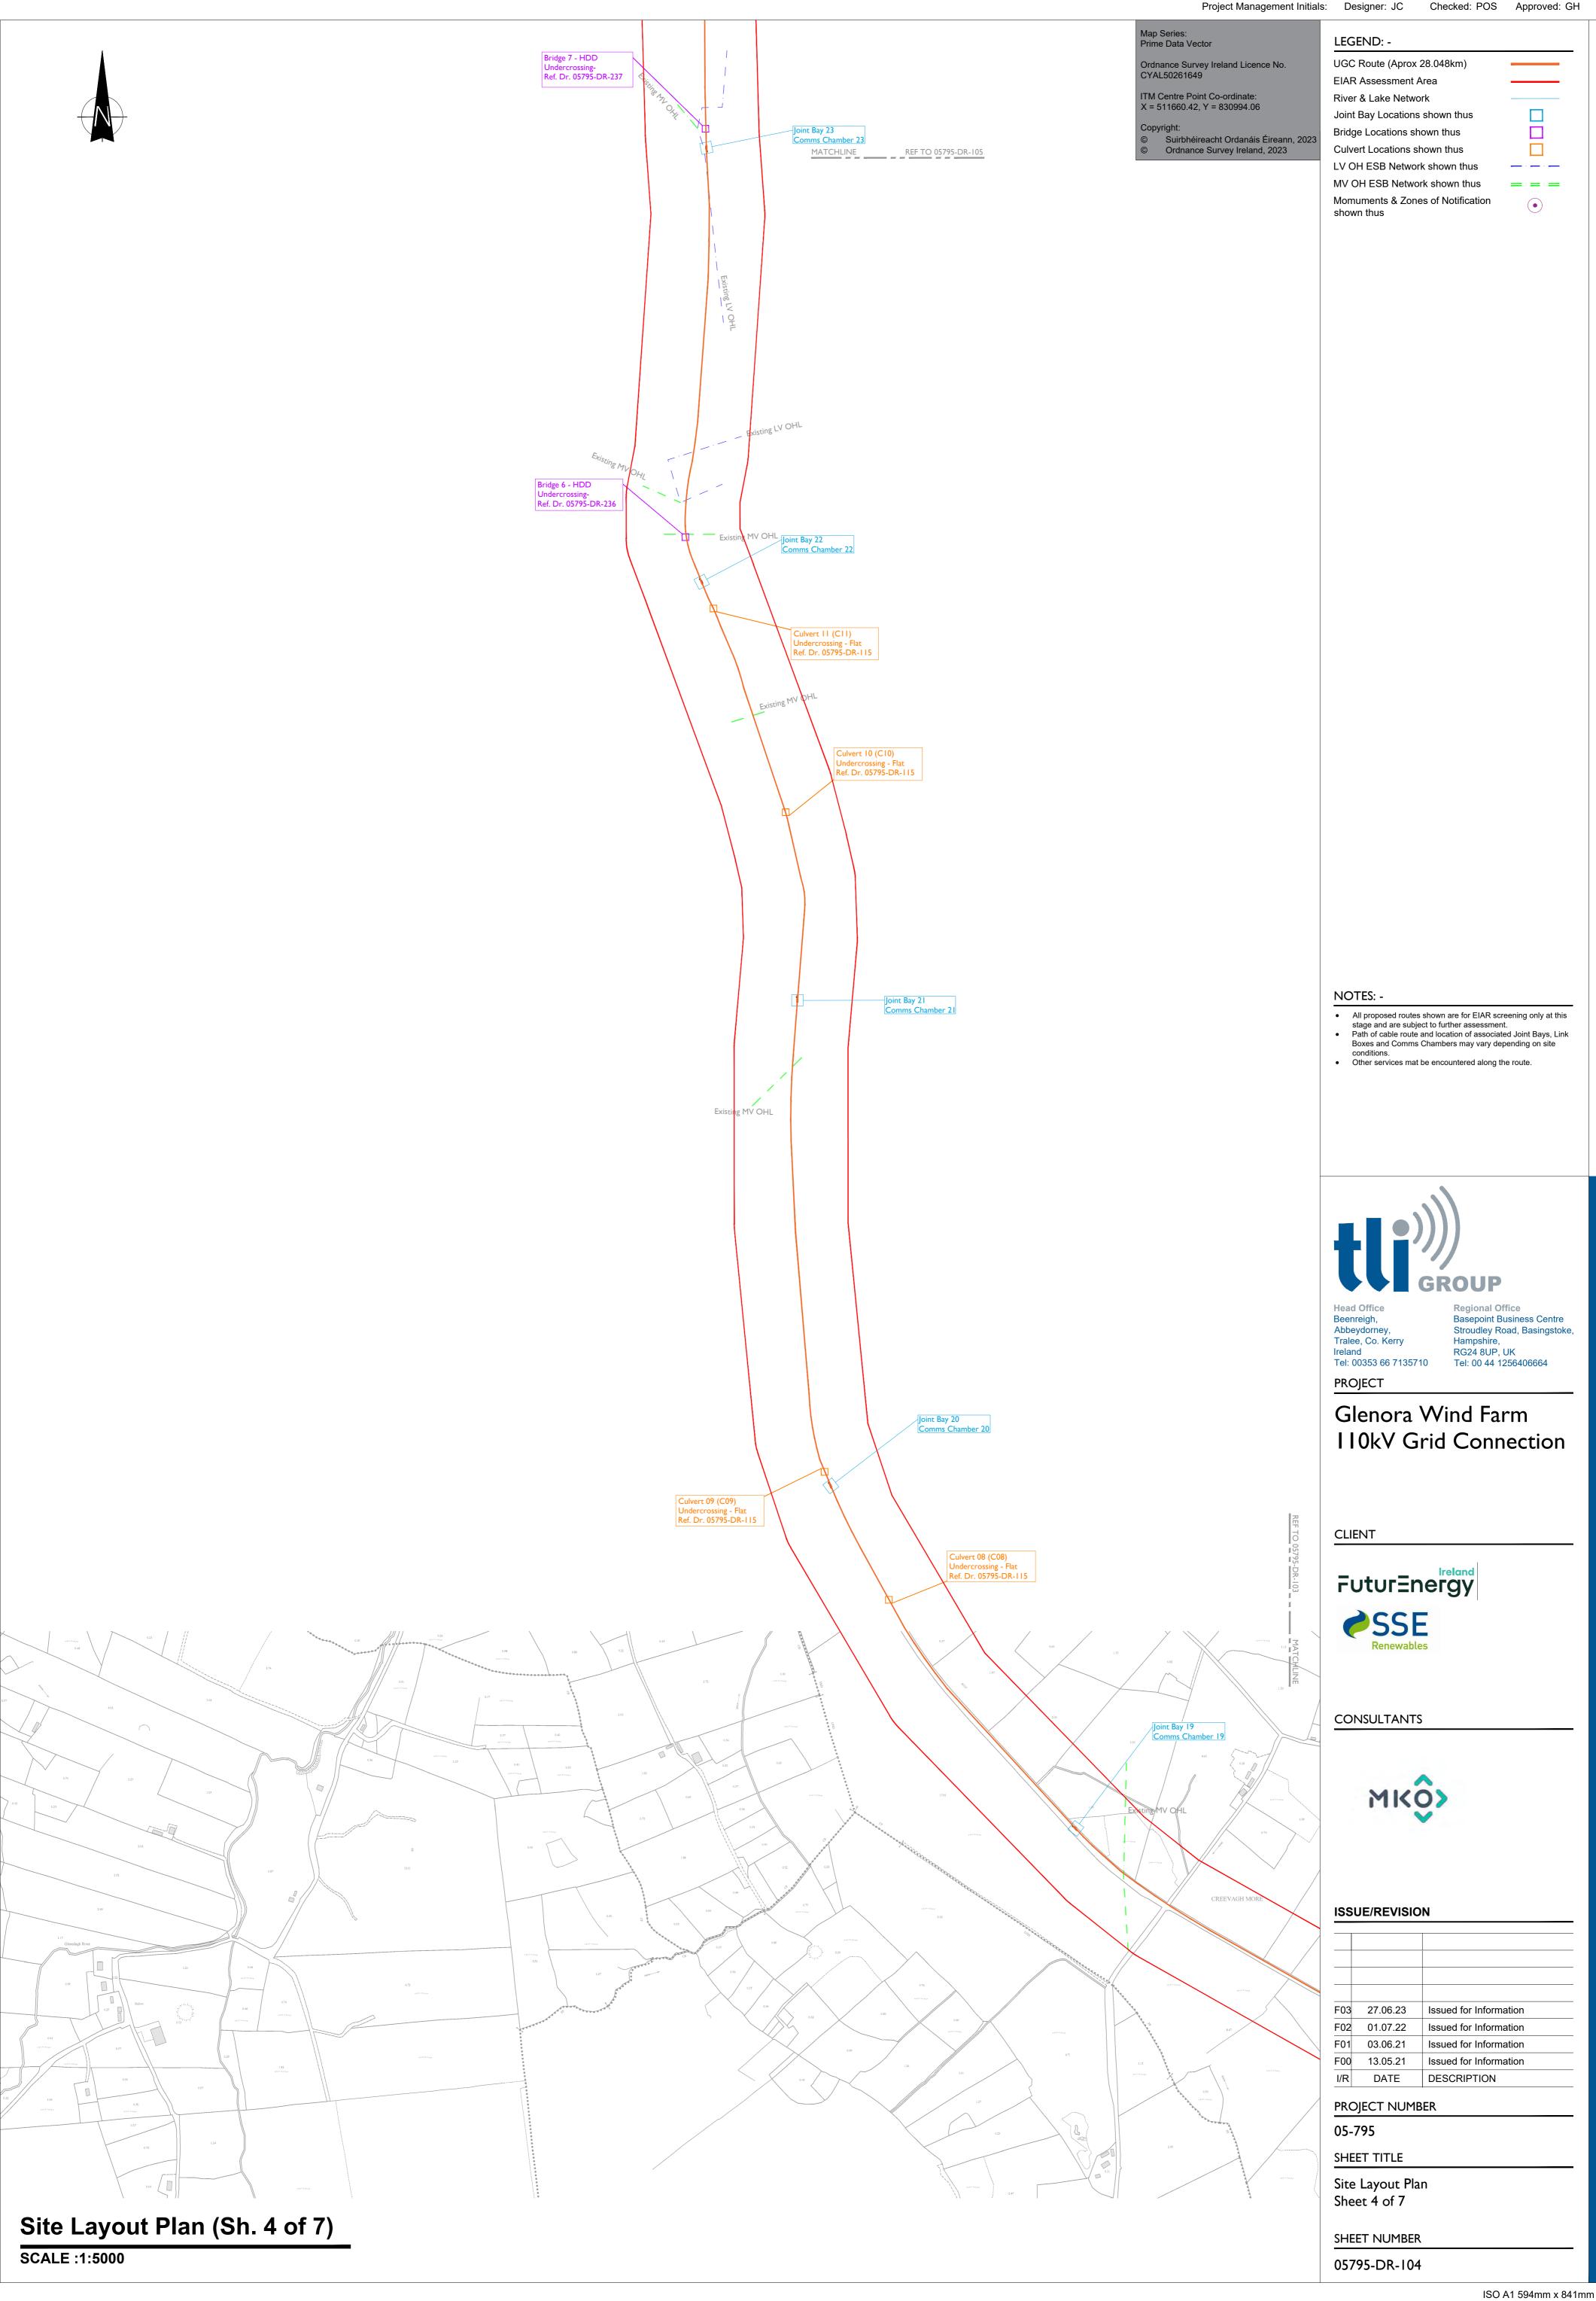

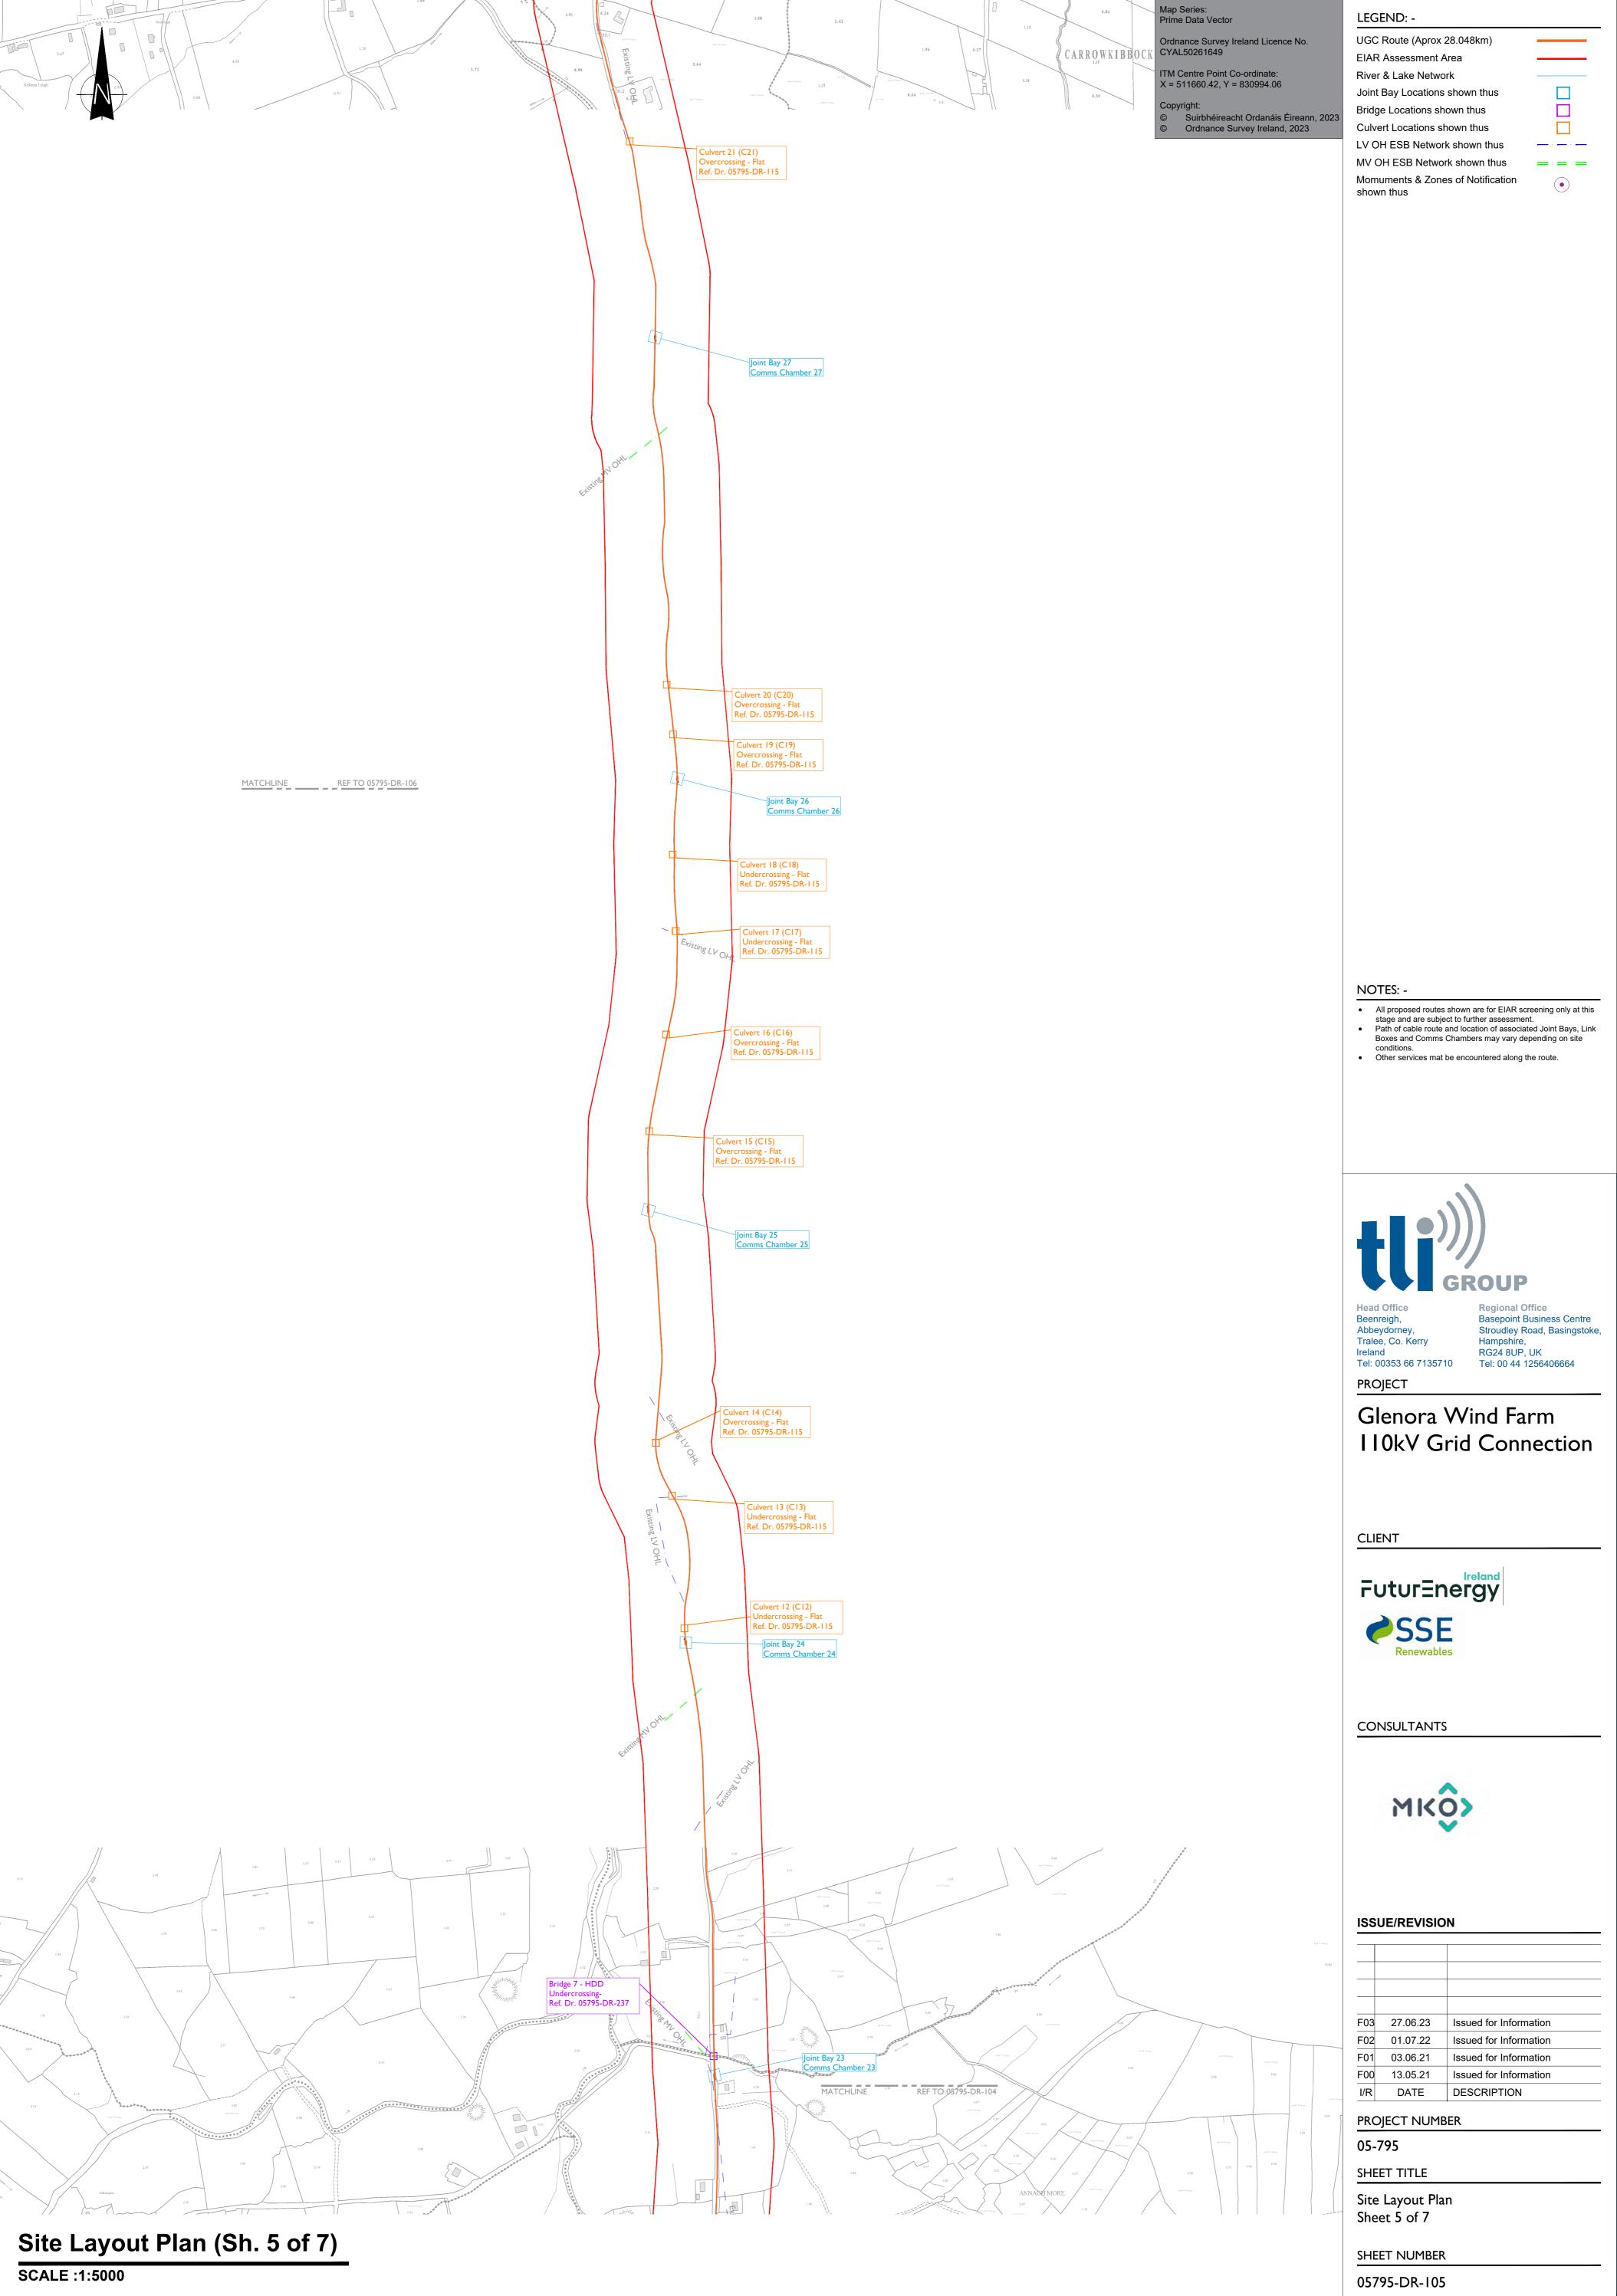

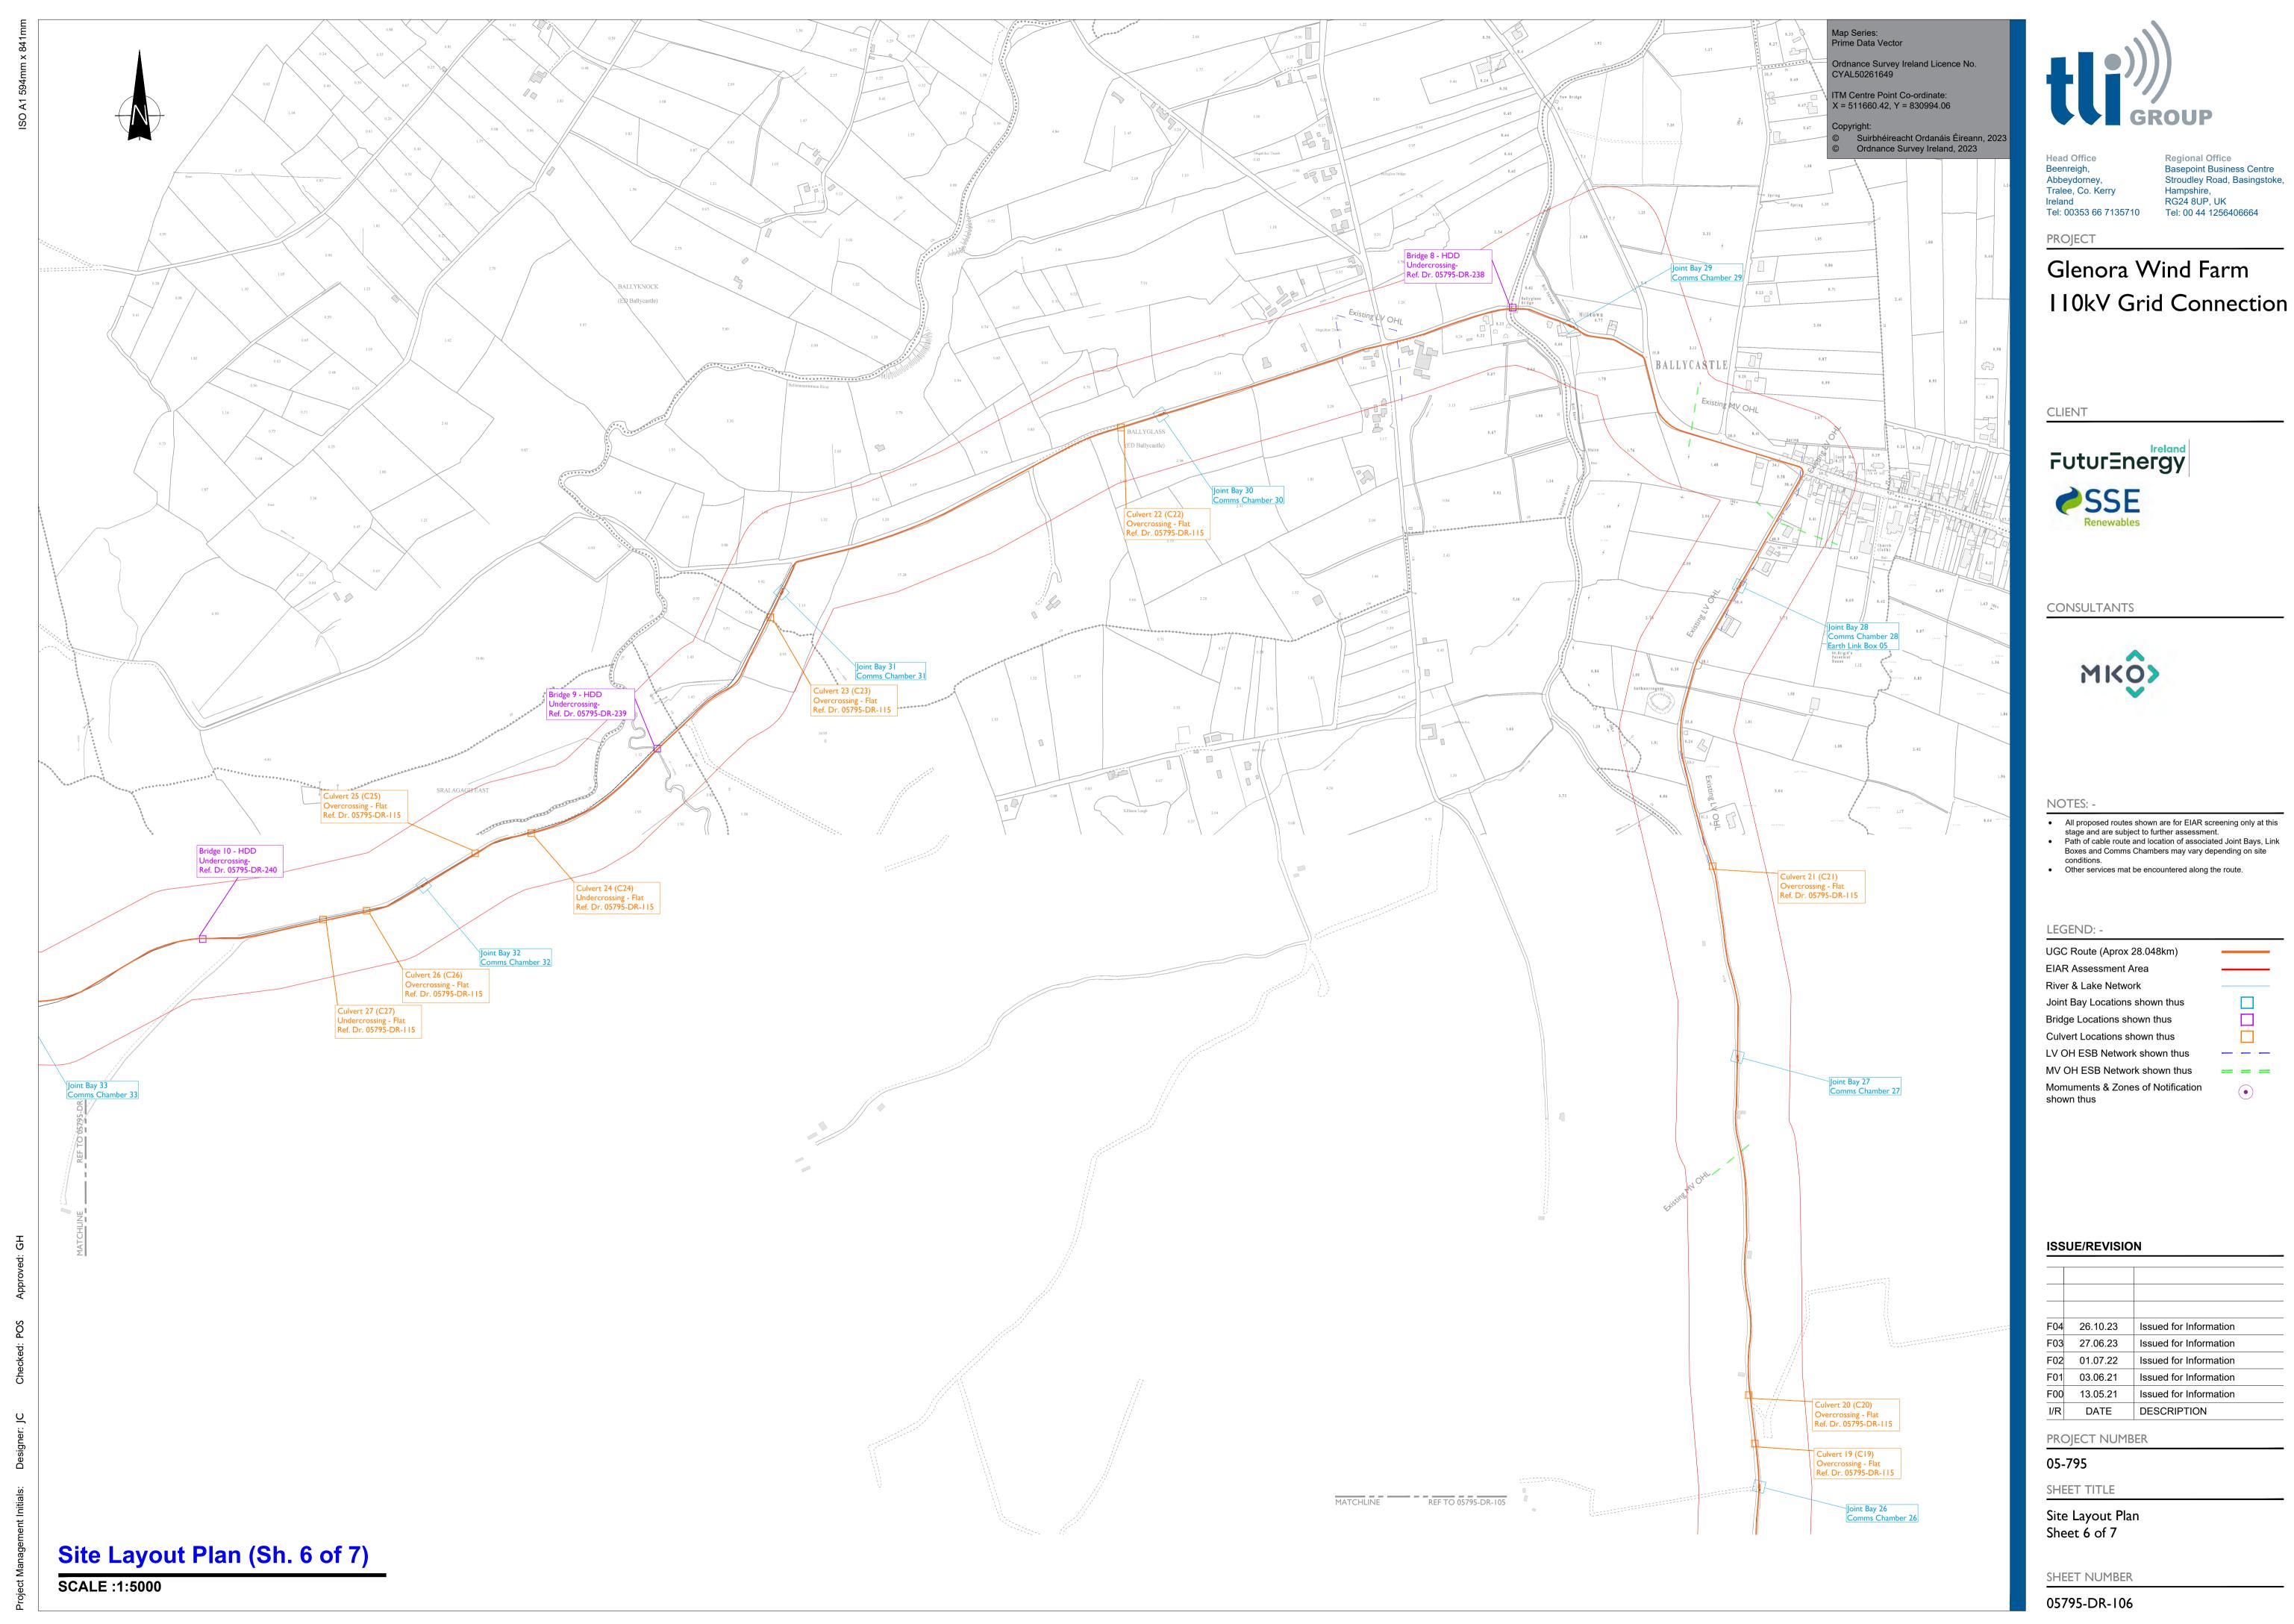

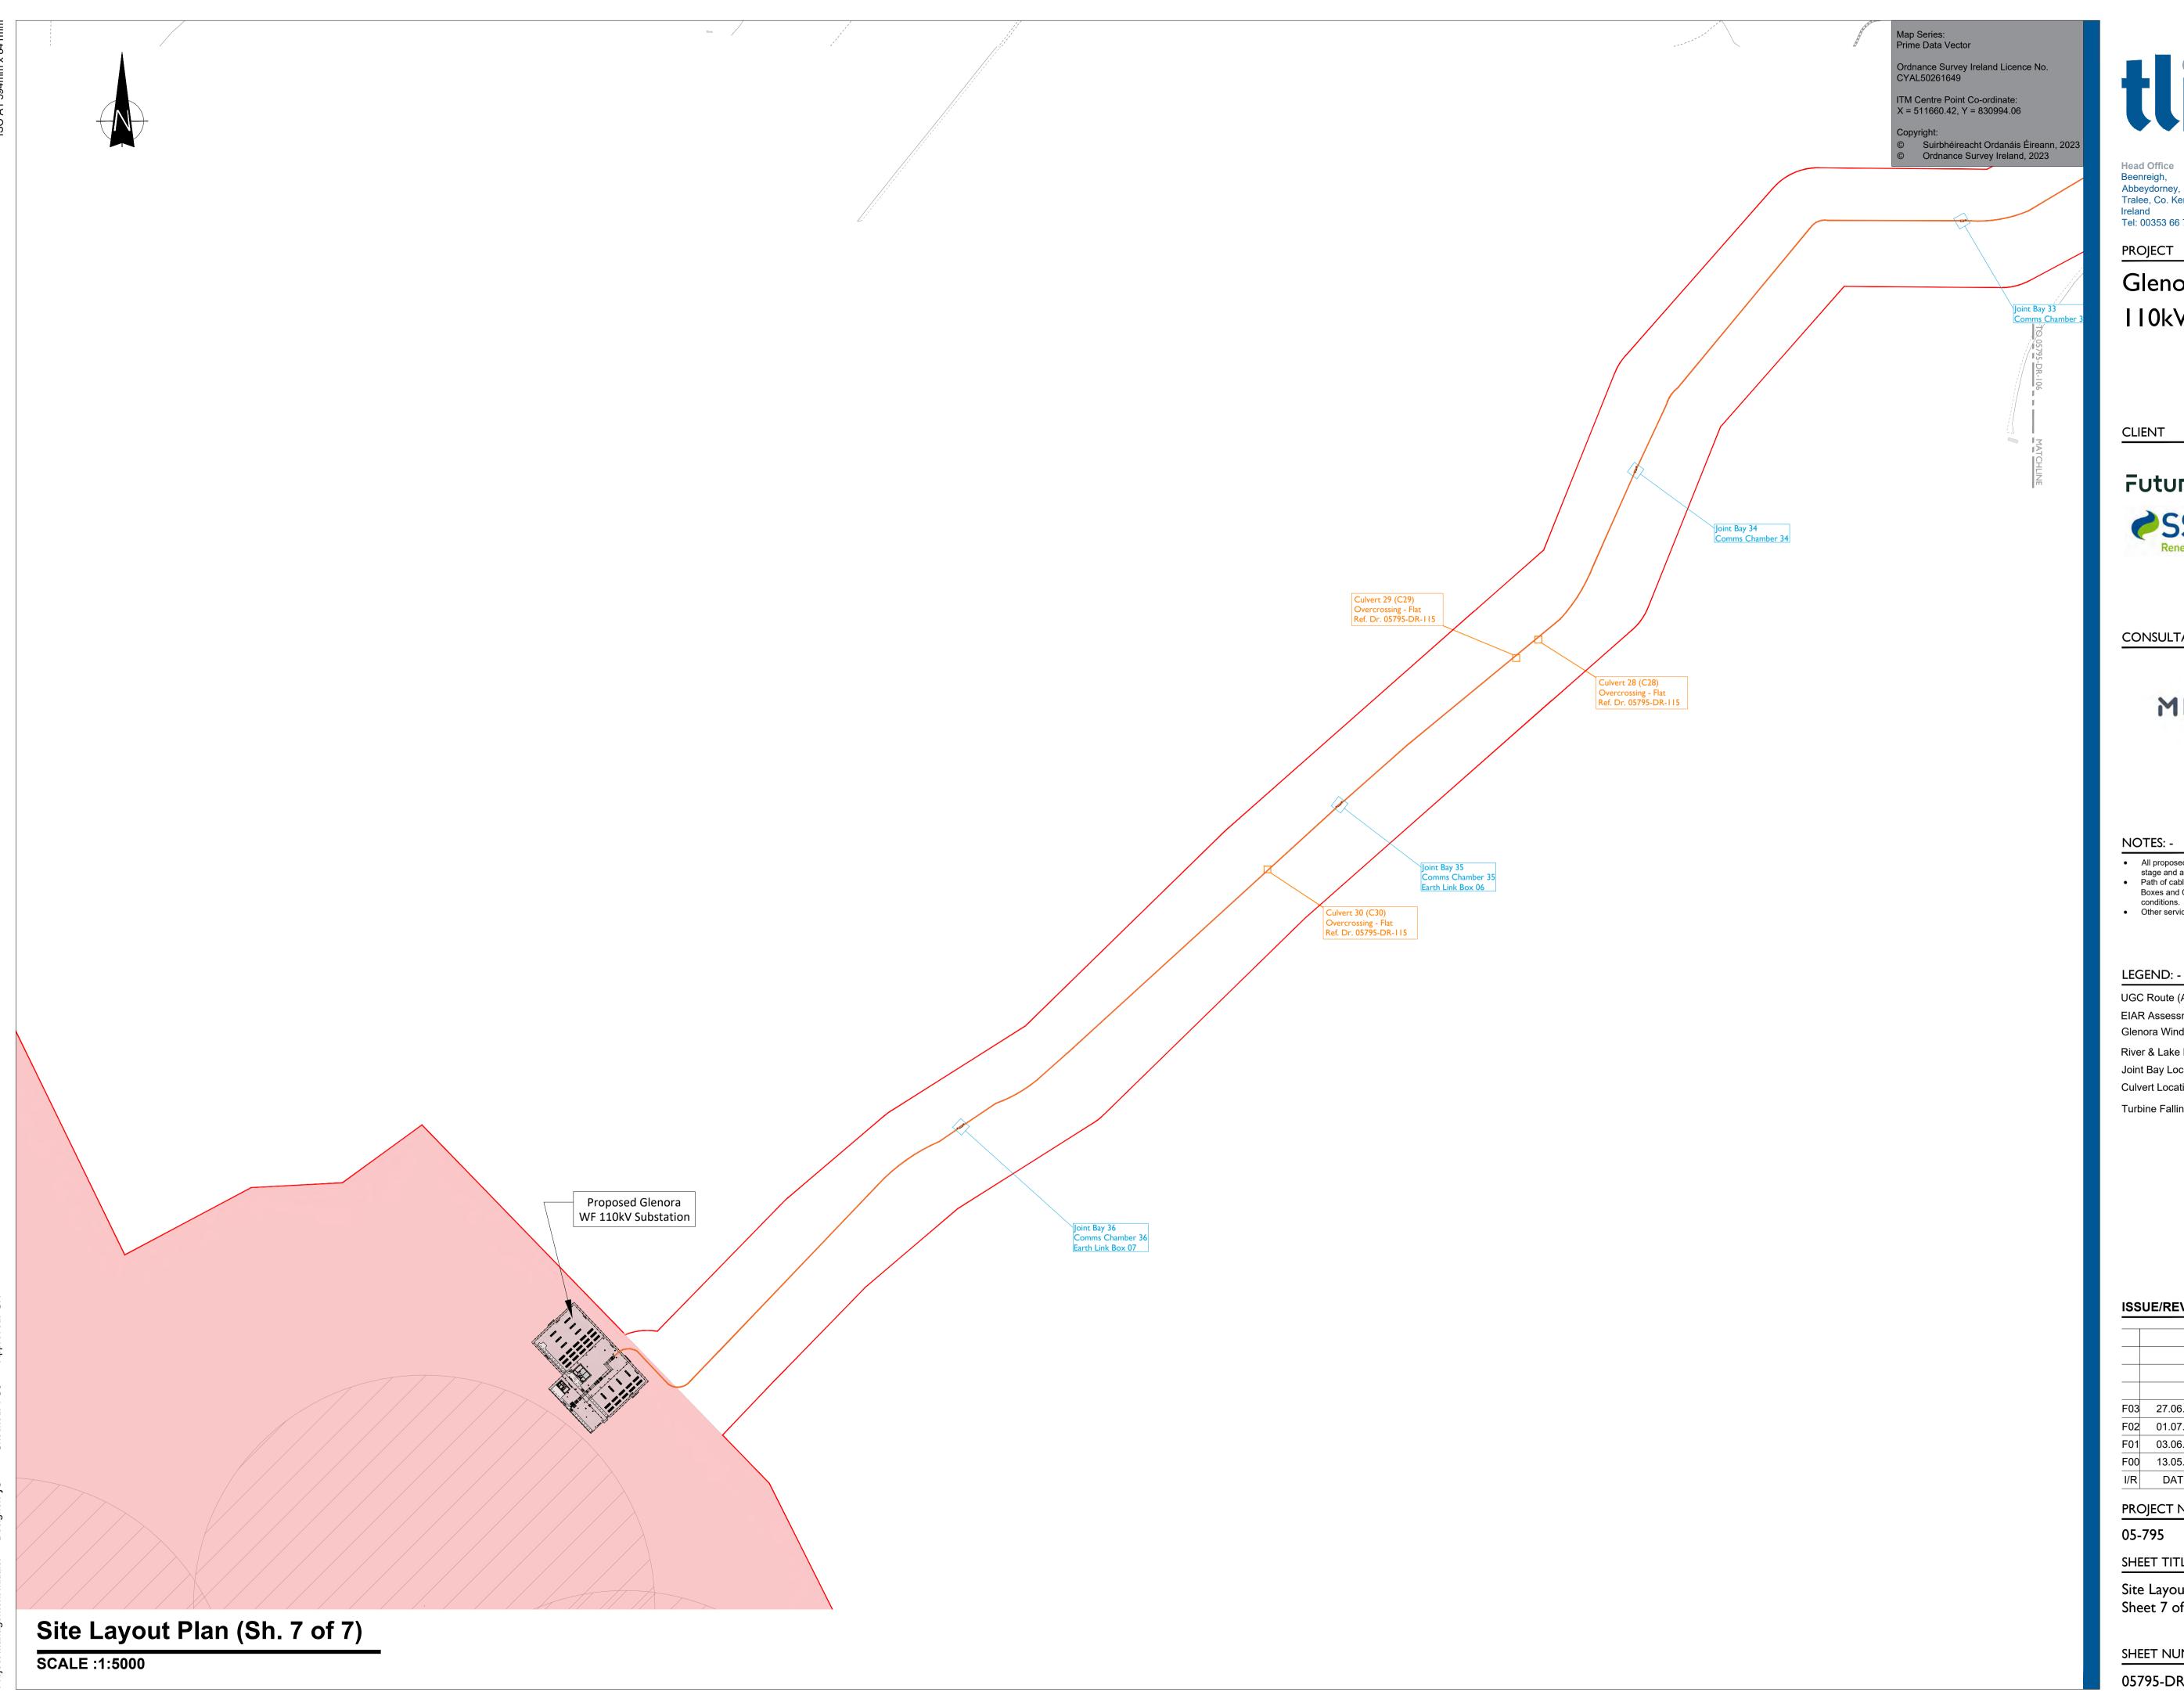



Abbeydorney, Tralee, Co. Kerry

Regional Office Basepoint Business Centre Stroudley Road, Basingstoke, Hampshire, Ireland RG24 8UP, UK
Tel: 00353 66 7135710 Tel: 00 44 1256406664

Glenora Wind Farm 110kV Grid Connection





CONSULTANTS



- All proposed routes shown are for EIAR screening only at this stage and are subject to further assessment.

 Path of cable route and location of associated Joint Bays, Link
- Boxes and Comms Chambers may vary depending on site
- Other services mat be encountered along the route.

UGC Route (Aprox 28.048km)

EIAR Assessment Area Glenora Wind Farm River & Lake Network

Joint Bay Locations shown thus Culvert Locations shown thus

Turbine Falling Distence



ISSUE/REVISION

F03	27.06.23	Issued for Information
F02	01.07.22	Issued for Information
F01	03.06.21	Issued for Information
F00	13.05.21	Issued for Information
I/R	DATE	DESCRIPTION

PROJECT NUMBER


SHEET TITLE

Site Layout Plan Sheet 7 of 7


SHEET NUMBER

NOTES:

- 1. This drawing is to be read in conjunction with relevant drawings, specifications and reports.
- Dimensions are in millimetres, unless noted otherwise.
- 3. Drawings are not to be scaled use figured dimensions only.
- 4. Reinstatement to comply with requirements of the relevant local Authority/Asset owner
- 5. Entrance & Exit ducts to be in line
- All material and workmanship to be in accordance with the NRA./TII specification for Roadworks, May 2005 and subsequent revisions
- Reinforced concrete to be a minimum grade C32/40, Sulphate resisting cement to be used where aggressive soil conditions apply, refer to table 6.1 of B.S. 8110.
- 8. Carraigeway covers and frames to be to B.S. 124.
- All covers to have ESB logo incorporated in them to the approval of Eirgrid
- Step irons to be hot dipped glvanised to B.S. 729 and positioned as shown on any chamber deeper than 700mm on the end remote from any side entry duct.
- 11. Concrete precast chamber and cover should be tested through a 5 point 40 tonnes vertical static loading test by an independent test company, if required, further details will be provided by Eirgrid.
- 12. Final position of C2 chambers shall be agreed with Eirgrid.13. In a forest environment backfill with lean mix outside the
- In a forest environment backfill with lean mix outside the cover frame.
- 14. This drawing is subject to Eirgrid design approval.

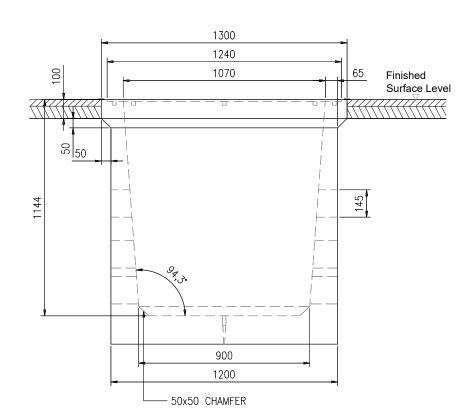


C2 Chamber Detail - Section A
SCALE 1:20

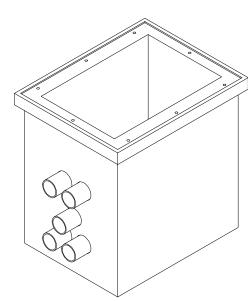

Isometric: C2 Chamber Arrangement

SCALE 1:20

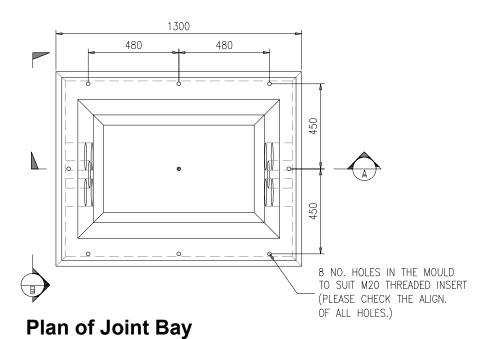

tti))))

SCALE 1:20

Head Office Beenreigh, Abbeydorney, Tralee, Co. Kerry Ireland Tel: 00353 66 7135710 CLIENT



PROJECT

Glenora W

Glenora Wind Farm 110kV Grid Connection

PROJECT NUMBER 05-795

SHEET NUMBER **05795-DR-109**

SHEET TITLE


Communications Chamber Details

DRAWING STATUS
For Information

ISSU	E/REVISION	
F00	01.07.22	Issued for Information
I/R	DATE	DESCRIPTION


RECESS TO BE 1-2mm MORE THAT FRAME OF COVER		
GRADE C30/37 CONCRETE TO BE USED AROUND LID	1030 970 735	147,5 Finished Surface Level
1294		Surface Level
3/4" BSP FITTING CAST INTO CONCRETE	930	

C2 Chamber Detail - Section B
SCALE 1:20

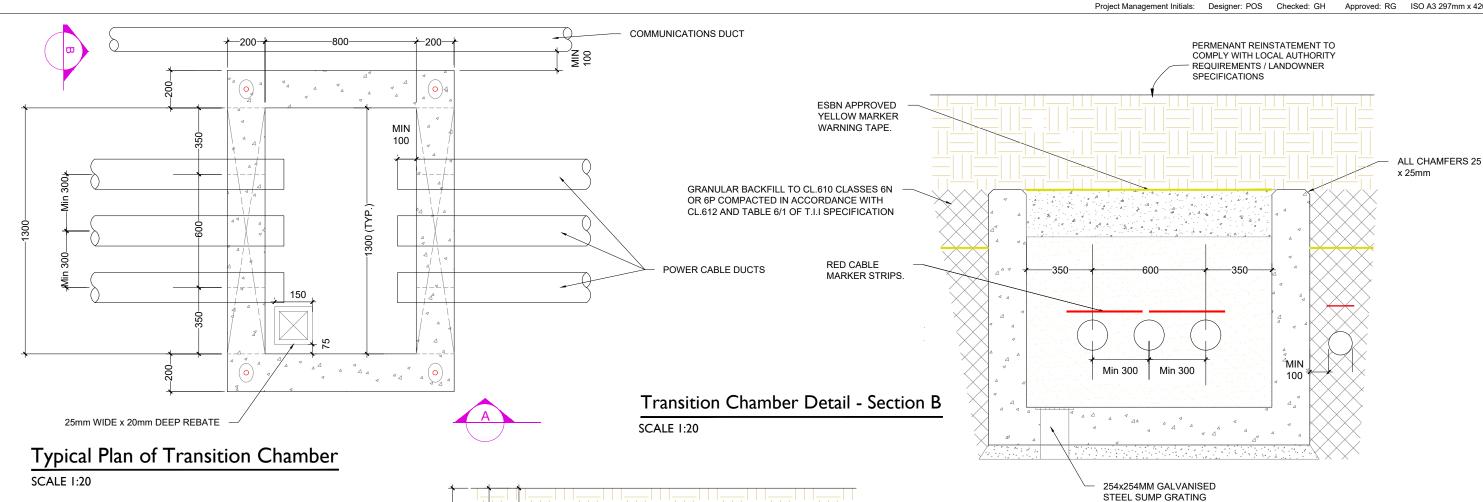

NOTES;

- ALL DIMENSION IN MILLIMETERS UNLESS OTHERWISE STATED,
- TELCOM DUCTS NOT TO BE ROUTED THROUGH TRANSITION CHAMBER IF TRANSITION CHAMBER IS USED TO INTERFACE WITH HDD SECTION, THEN THE TELECOMS DUCT SDR 17.6 SHOULD BE CHAMFERED WHEN COUPLED
- WITH SDR 11 DUCTS REINSTATEMENTS TO COMPLY WITH REQUIREMENTS OF THE RELEVANT LOCAL AUTHORITY/ASSET OWNER
- TEMPORARY SUPPORTS TO THE SIDES OF THE EXCAVATION MAY BE REQUIRED DEPENDENT ON THE SUBSOIL,
- THE CONSTRUCTION SHOWN, IS APPLICABLE ONLY WHERE THE THE SUBSOIL AT FORMATION LEVEL EXCEEDS 100kN/m BEARING CAPACITY
- ALL MATERIALS AND WORKMANSHIP TO BE IN ACCORDANCE WITH NRA/T.I.I. SPECIFICATION FOR ROADWORKS, MAY 2005 & SUBSEQUENT REVISIONS
- THE CENTRE LINE OF THE DUCTS ENTERING THE CHAMBER SHALL BE ALIGNED WITH THE DUCTS ON THE OPPOSITE SIDE, SO THAT THE CABLE IS PULLED IN A STRAIGHT LINE
- DUCTS SHALL APPROACH THE CHAMBER IN A STRAIGHT ALIGNMENT (HORIZONTAL OR VERTICAL) FOR A MINIMUM OF 3 METERS BEFORE THE WALL
- CARRAIGEWAY COVERS AND FRAMES TO BE TO B.S EN 124.
- THE DEPTH FROM GROUND LEVEL TO THE TOP OF WALL CONSTRUCTION SHALL BE 500mm IN CULVATED FIELDS AND GRASSED LANDS.
- 12. FINAL POSITION OF TRANSITION CHAMBERS SHALL BE AGREED WITH **ESB/EIRGRID**

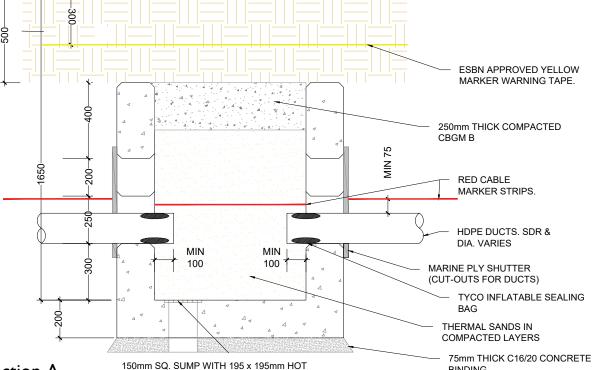

Isometric: Chamber Arrangement SCALE 1:20

Transition Chamber Detail - Section A SCALE 1:20

DIPPED GALVINISED STEEL SUMP GRATING TO I.S. EN ISO 1461, FOLLOWING BLAST CLEANING TO Sa 2½ TO B.S. 7079 ½ TO B.S. 7079



Head Office Beenreigh, Abbeydorney, Tralee, Co. Kerry Ireland Tel: 00353 66 7135710 CLIENT

FuturEnergy



PROJECT

Glenora Wind Farm 110kV Grid Connection

PROJECT NUMBER 05-795

SHEET NUMBER 05795-DR-110 SHEET TITLE **Typical Transition Chamber Details DRAWING STATUS** For Information

BINDING

ISSU	ISSUE/REVISION					
F00	01.07.22	Issued for Information				
I/R	DATE	DESCRIPTION				


drawings, specifications and reports.

subsequent revisions

conditions apply.

NOTES:



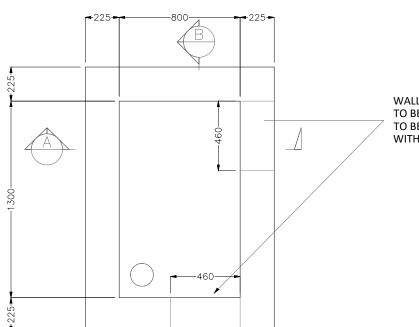

WALL OPENING 460x325 MAX. ACTUAL SIZE TO BE FORMED TO SUIT DUCT ENTRIES. VOIDS TO BE SEALED AND SURFACES MADE GOOD WITH CLASS 1 MORTAR.

6. Carriageway covers and frames to be to B.S. 124.

7. All covers to have ESB logo incorporated in them to the approval of Eirgrid

1. This drawing is to be read in conjunction with relevant

2. Dimensions are in millimeters, unless noted otherwise. 3. Drawings are not to be scaled use figured dimensions only. 4. All material and workmanship to be in accordance with the


NRA./TII specification for Roadworks, May 2005 and

Sulphate resisting cement to be used where aggressive soil

5. Reinforced concrete to be a minimum grade C32/40,

- 8. Brickwork to be class B Engineering, beds and Joints to be
- 9. Final position of Link Box to be agreed with Eirgrid prior to

Link Box Chamber Detail - Plan

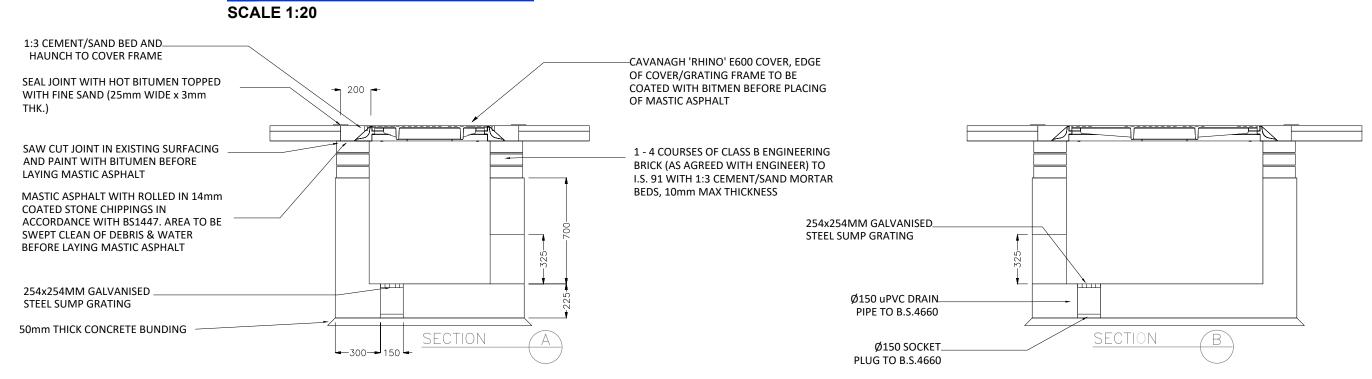

Link Box Chamber Detail - Section A-A SCALE 1:20

Link Box Chamber Detail - Section B-B **SCALE 1:20**



Head Office Beenreigh, Abbeydorney, Tralee, Co. Kerry Ireland Tel: 00353 66 7135710




Glenora Wind Farm 110kV Grid Connection

PROJECT NUMBER 05-795

SHEET NUMBER 05795-DR-111 SHEET TITLE Link Box Chamber Details

ISSU	ISSUE/REVISION		
<u></u>	04.07.22	Issued for Information	
F00	01.07.22		
I/R	DATE	DESCRIPTION	

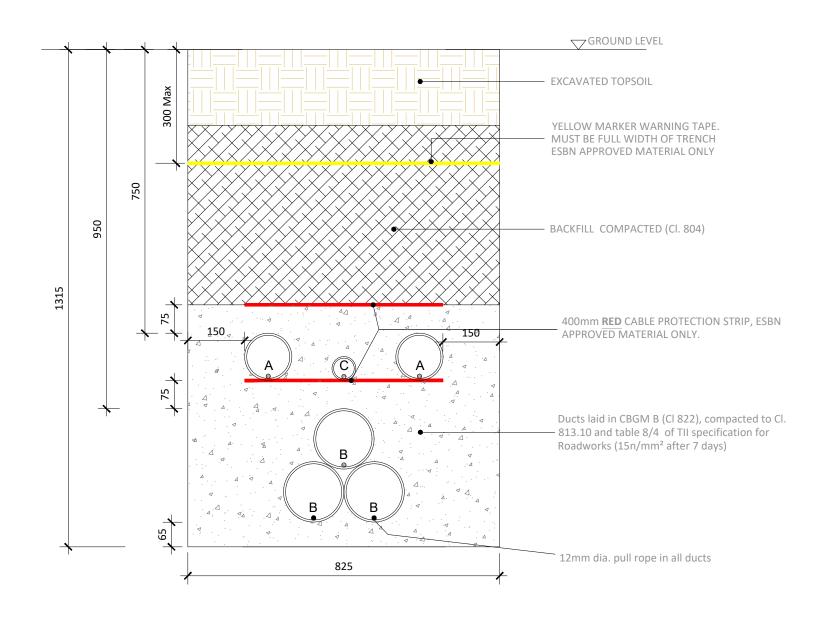

A = 125mm: Outer Diameter HDPE ESB Approved Duct, SDR=17.6 B= 160mm : Outer Diameter HDPE ESB Approved Duct, SDR= 21

C = 63mm: ECC Earth Continuity Conductor

Section Through Off Road Sections

SCALE 1:10

ALL REINSTATEMENT WORKS ARE TO BE IN ACCORDANCE WITH LANDOWNER REQUIREMENTS

Reinstatement details based on Guidelines for Managing Openings in Public Roads - SD14



This drawing is to be read in conjunction with relevant drawings, specifications and reports

Dimensions are in millimeters, unless noted

Drawings are not to be scaled use figured

Note:

otherwise

dimensions only

Head Office Beenreigh, Abbeydorney, Tralee, Co. Kerry Ireland Tel: 00353 66 7135710 CLIENT



PROJECT
Glenora Wind Farm

05-795

110kV Grid Connection


PROJECT NUMBER SHEET NUMBER


SHEET NUMBER 05795-DR-112 **Ducting through Off Road Sections**

DRAWING STATUS
For Information

SHEET TITLE

ISSUI	ISSUE/REVISION		
F00	01.07.22	Issued for Information	
I/R	DATE	DESCRIPTION	

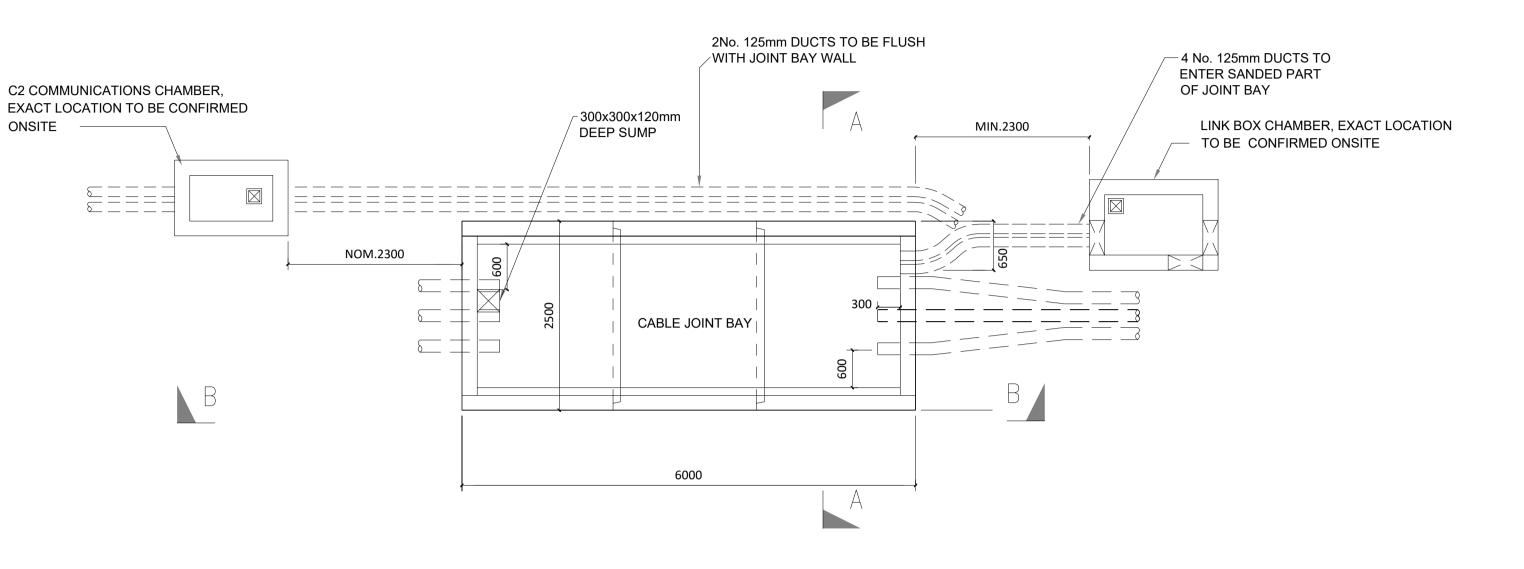

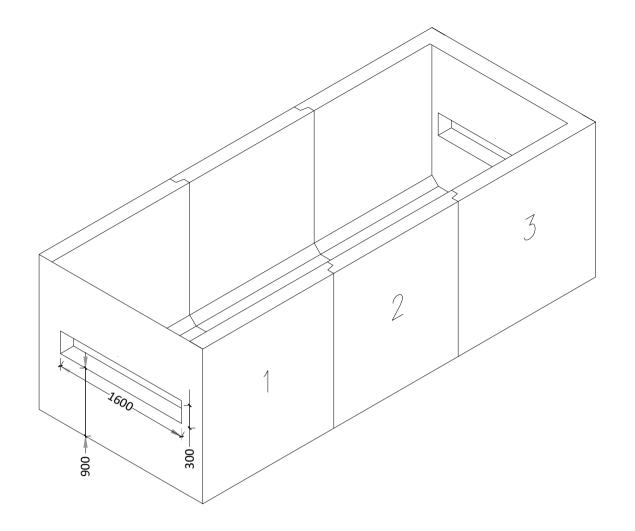

ISOMETRIC VIEW PRECAST CHAMBER SCALE 1:50

LINK BOX CHAMBER COMMS CHAMBER PRECAST CONCRETE EXISTING ROAD LEVEL CONSTRUCTION A2 B1 B1 1:6 GRADIENT 1:6 GRADIENT - 50mm SAND BLINDING 200mm LAYER OF CL. 804 SUBJECT TO GROUND CONDITIONS (NOTE 5)

SECTION B-B

SCALE 1:50


GENERAL NOTES:

- 1. THIS DRAWING IS TO BE USED ONLY FOR THE PURPOSE OF ISSUE AND IS SUBJECT TO AMENDMENT.
- 2. THIS DRAWING IS TO BE READ IN CONJUNCTION WITH ALL OTHER RELEVANT INFORMATION

PLAN VIEW

SCALE 1:50

- 3. DO NOT SCALE FROM THIS DRAWING, USE ONLY PRINTED DIMENSIONS. 4. ALL DIMENSIONS ARE IN MILLIMETRES UNLESS DEFINED OTHERWISE.
- STANDARD FOUNDATIONS ARE BASED ON THE FORMATION AT THE BASE OF THE EXCAVATION SHOWN BEING SUITABLE FOR A MINIMUM BEARING PRESSURE OF 100kN/m2. SUITABILITY OF STANDARD JOINT BAY FOUNDATIONS CAN ONLY BE CONFIRMED FOLLOWING GROUND INVESTIGATION. HAND VANE TESTS SHALL BE
- REQUIRED AS PER GI SPECIFICATION. WHERE SPECIFIED MINIMUM BEARING PRESSURE IS NOT ACHIEVABLE, AND WHERE PEAT IS ENCOUNTERED, THE CONTRACTOR SHALL REFER TO THE ENGINEER FOR GUIDANCE. 6. THE LENGTH OF BONDING LEAD LENGTH SHALL IN NO CASE EXCEED 10M. NO JOINTS IN BONDING CABLE ARE
- 7. ALL EARTHING SHALL BE IN ACCORDANCE WITH ENA ER C55 AND EIRGRID/ESBN FUNCTIONAL SPECIFICATION
- 8. THE DEPTH FROM GROUND/ROAD LEVELTO THE TOP OF THE CONCRETE WALL SHALL BE 500MM - IN CULTIVATED FIELDS & GRASS LAND
 - 300MM IN PAVED ROADS AND GRASS VERGES C. 350MM - IN PAVED CITY ROADS AND GRASS VERGES
- 9. LINK BOX CHAMBERS TO BE POSITIONED AT THE EDGE OR OFF ROAD
- 10. LINK BOX CHAMBERS AND C2 COMM CHAMBERS FINAL POSITIONING TO BE AGREED WITH EIRGRID
 - PRIOR TO INSTALLATION

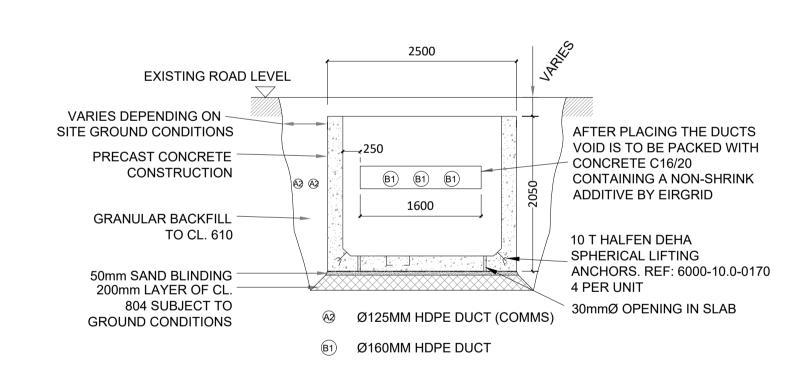

SECTION A-A SCALE 1:50



Beenreigh, Abbeydorney, Tralee, Co. Kerry Tel: 00353 66 7135710

Regional Office Basepoint Business Centre Stroudley Road, Basingstoke, RG24 8UP, UK Tel: 00 44 1256406664

PROJECT

Glenora Wind Farm 110kV Grid Connection

CLIENT



CONSULTANTS



NOTES: -See General Notes

LEGEND: -

ISSUE/REVISION

	F00	01.07.22	Issued for Information
	I/R	DATE	DESCRIPTION


PROJECT NUMBER

05-795

SHEET TITLE

110kV Joint Bay General Arrangement and Details

SHEET NUMBER

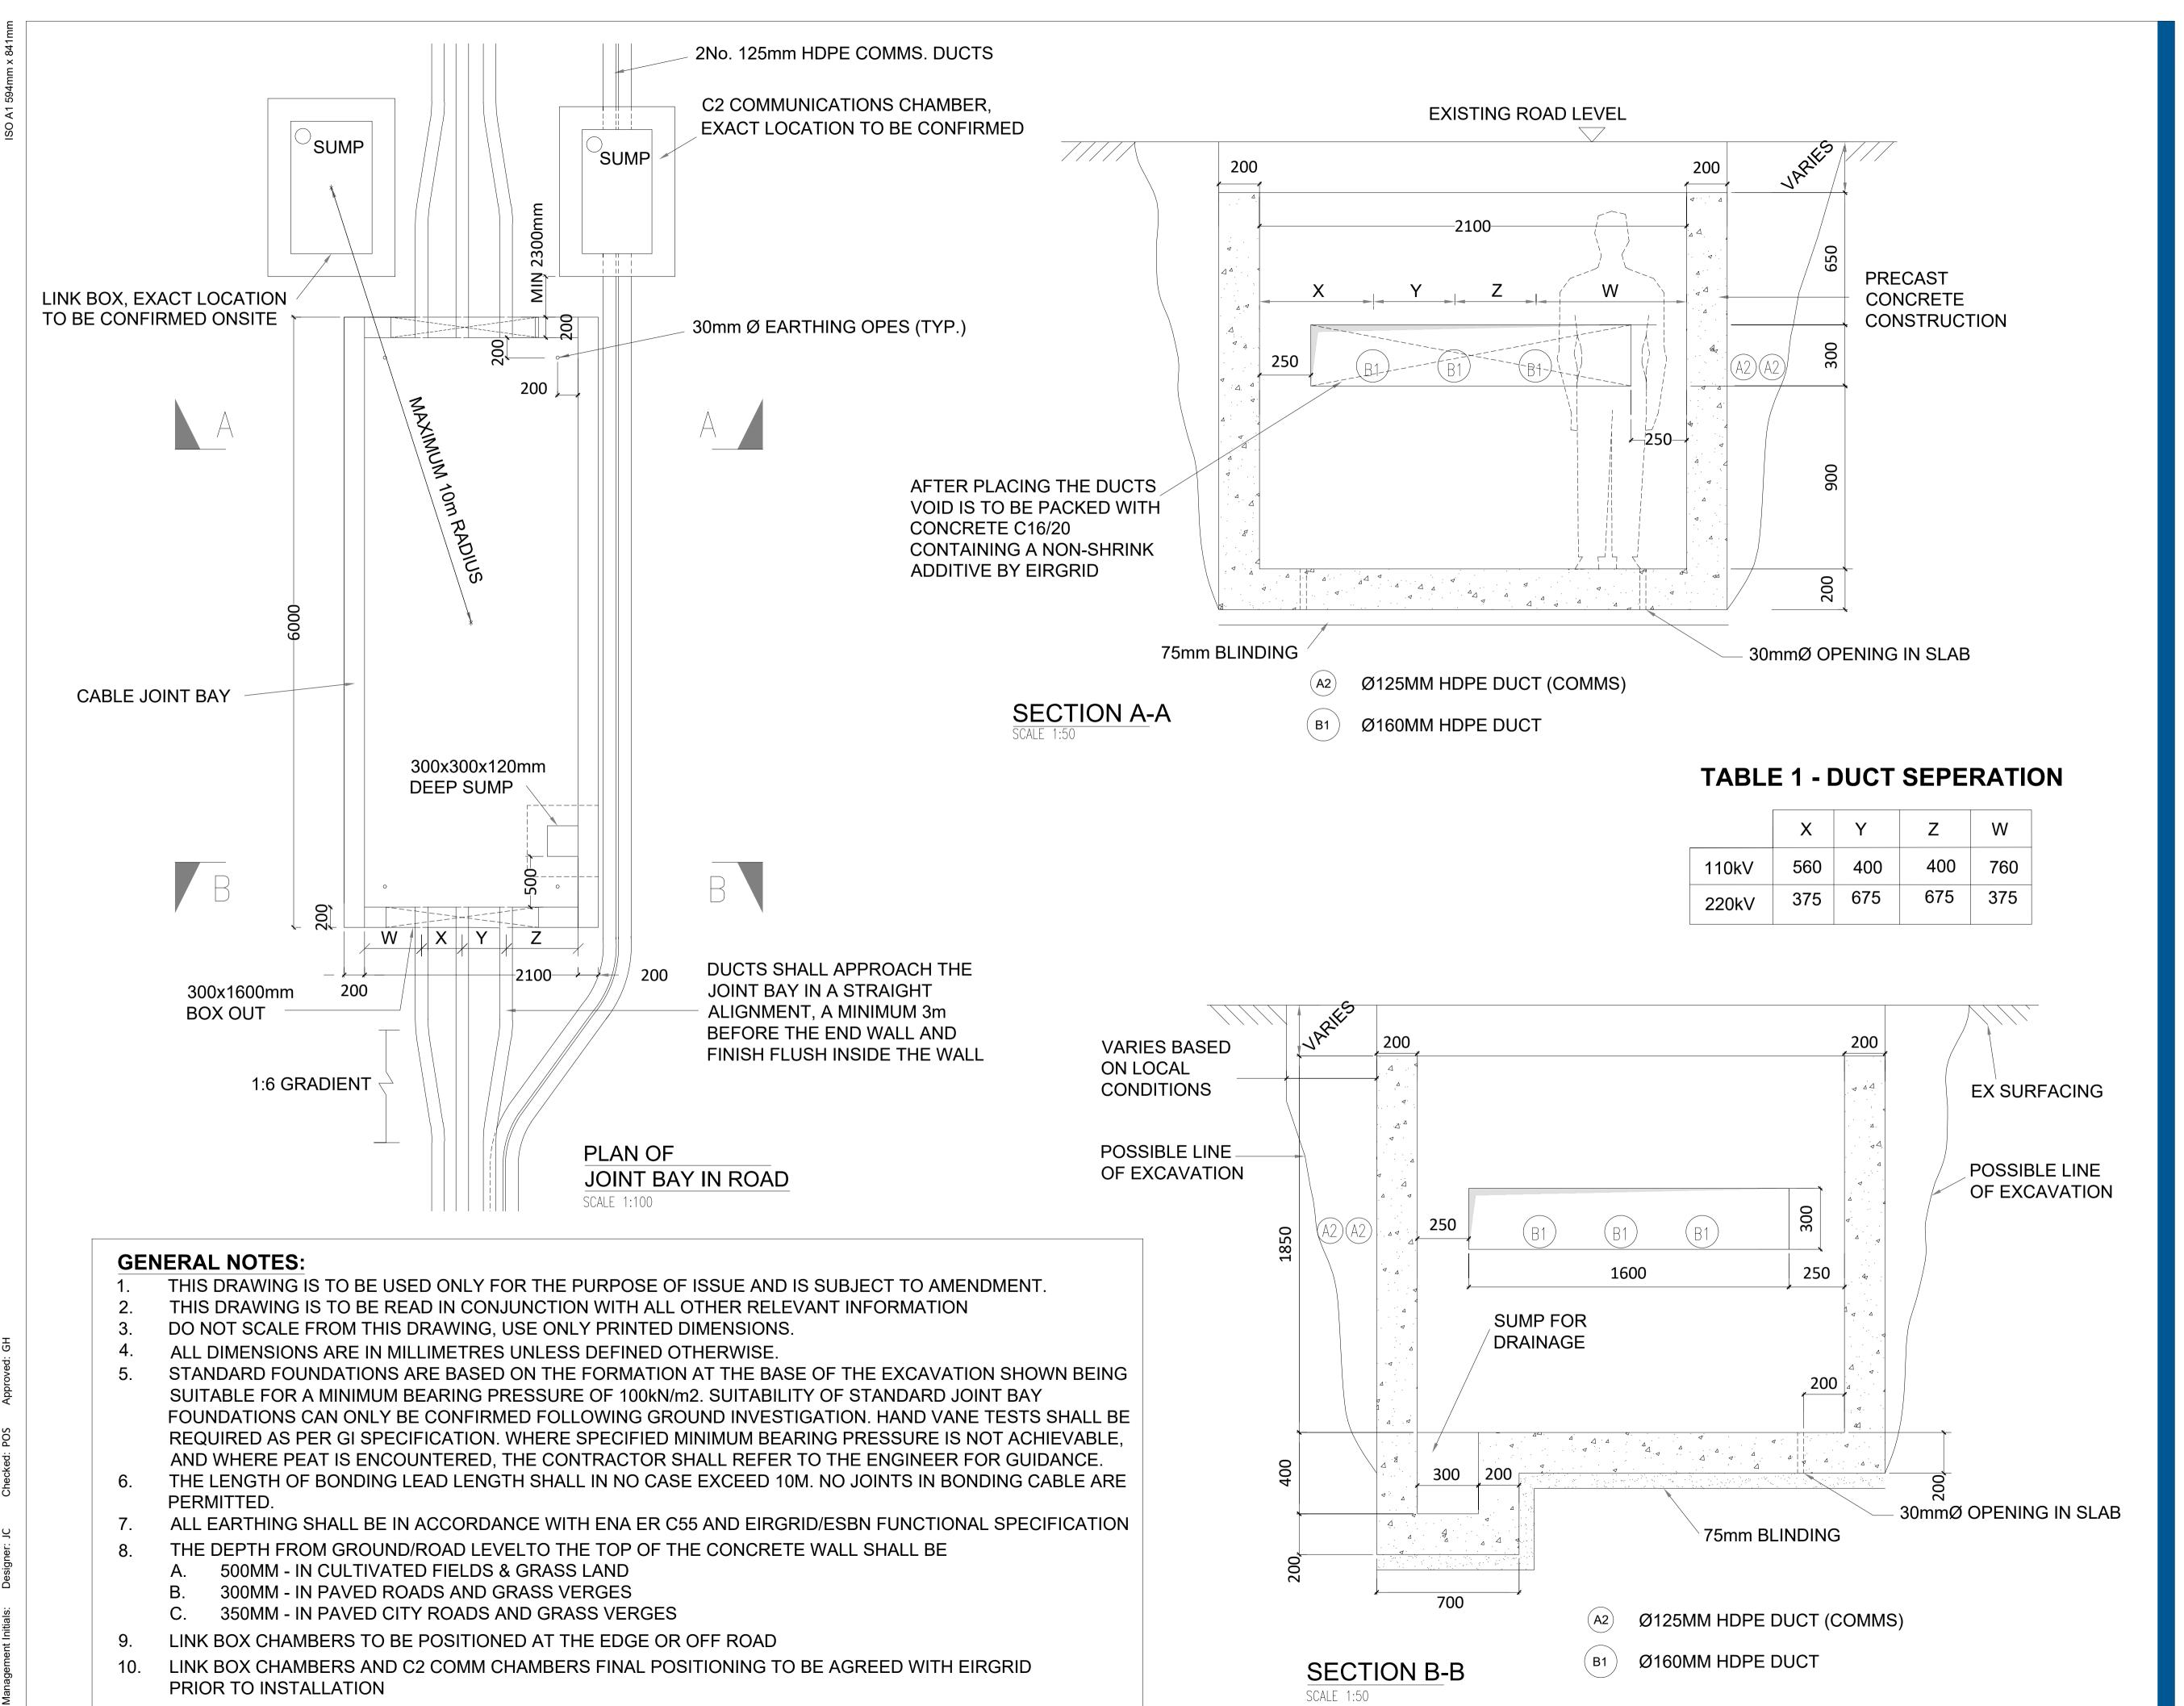

t (P))))

Head Office
Beenreigh,
Abbeydorney,
Tralee, Co. Ker
Ireland

Regional Office
Basepoint Business Centre
Stroudley Road, Basingstoke,
Hampshire,
RG24 8UP, UK
Tel: 00 44 1256406664

PROJECT

Glenora Wind Farm 110kV Grid Connection

CLIENT



CONSULTANTS



NOTES: See General Notes

LEGEND: -

ISSUE/REVISION

F00	01.07.22	Issued for Information
I/R	DATE	DESCRIPTION

PROJECT NUMBER
05-795


SHEET TITLE

110kV Joint Bay Section Details

SHEET NUMBER

05795-DR-114

Management Initials: Designer IC Checked: POS Approved: GI

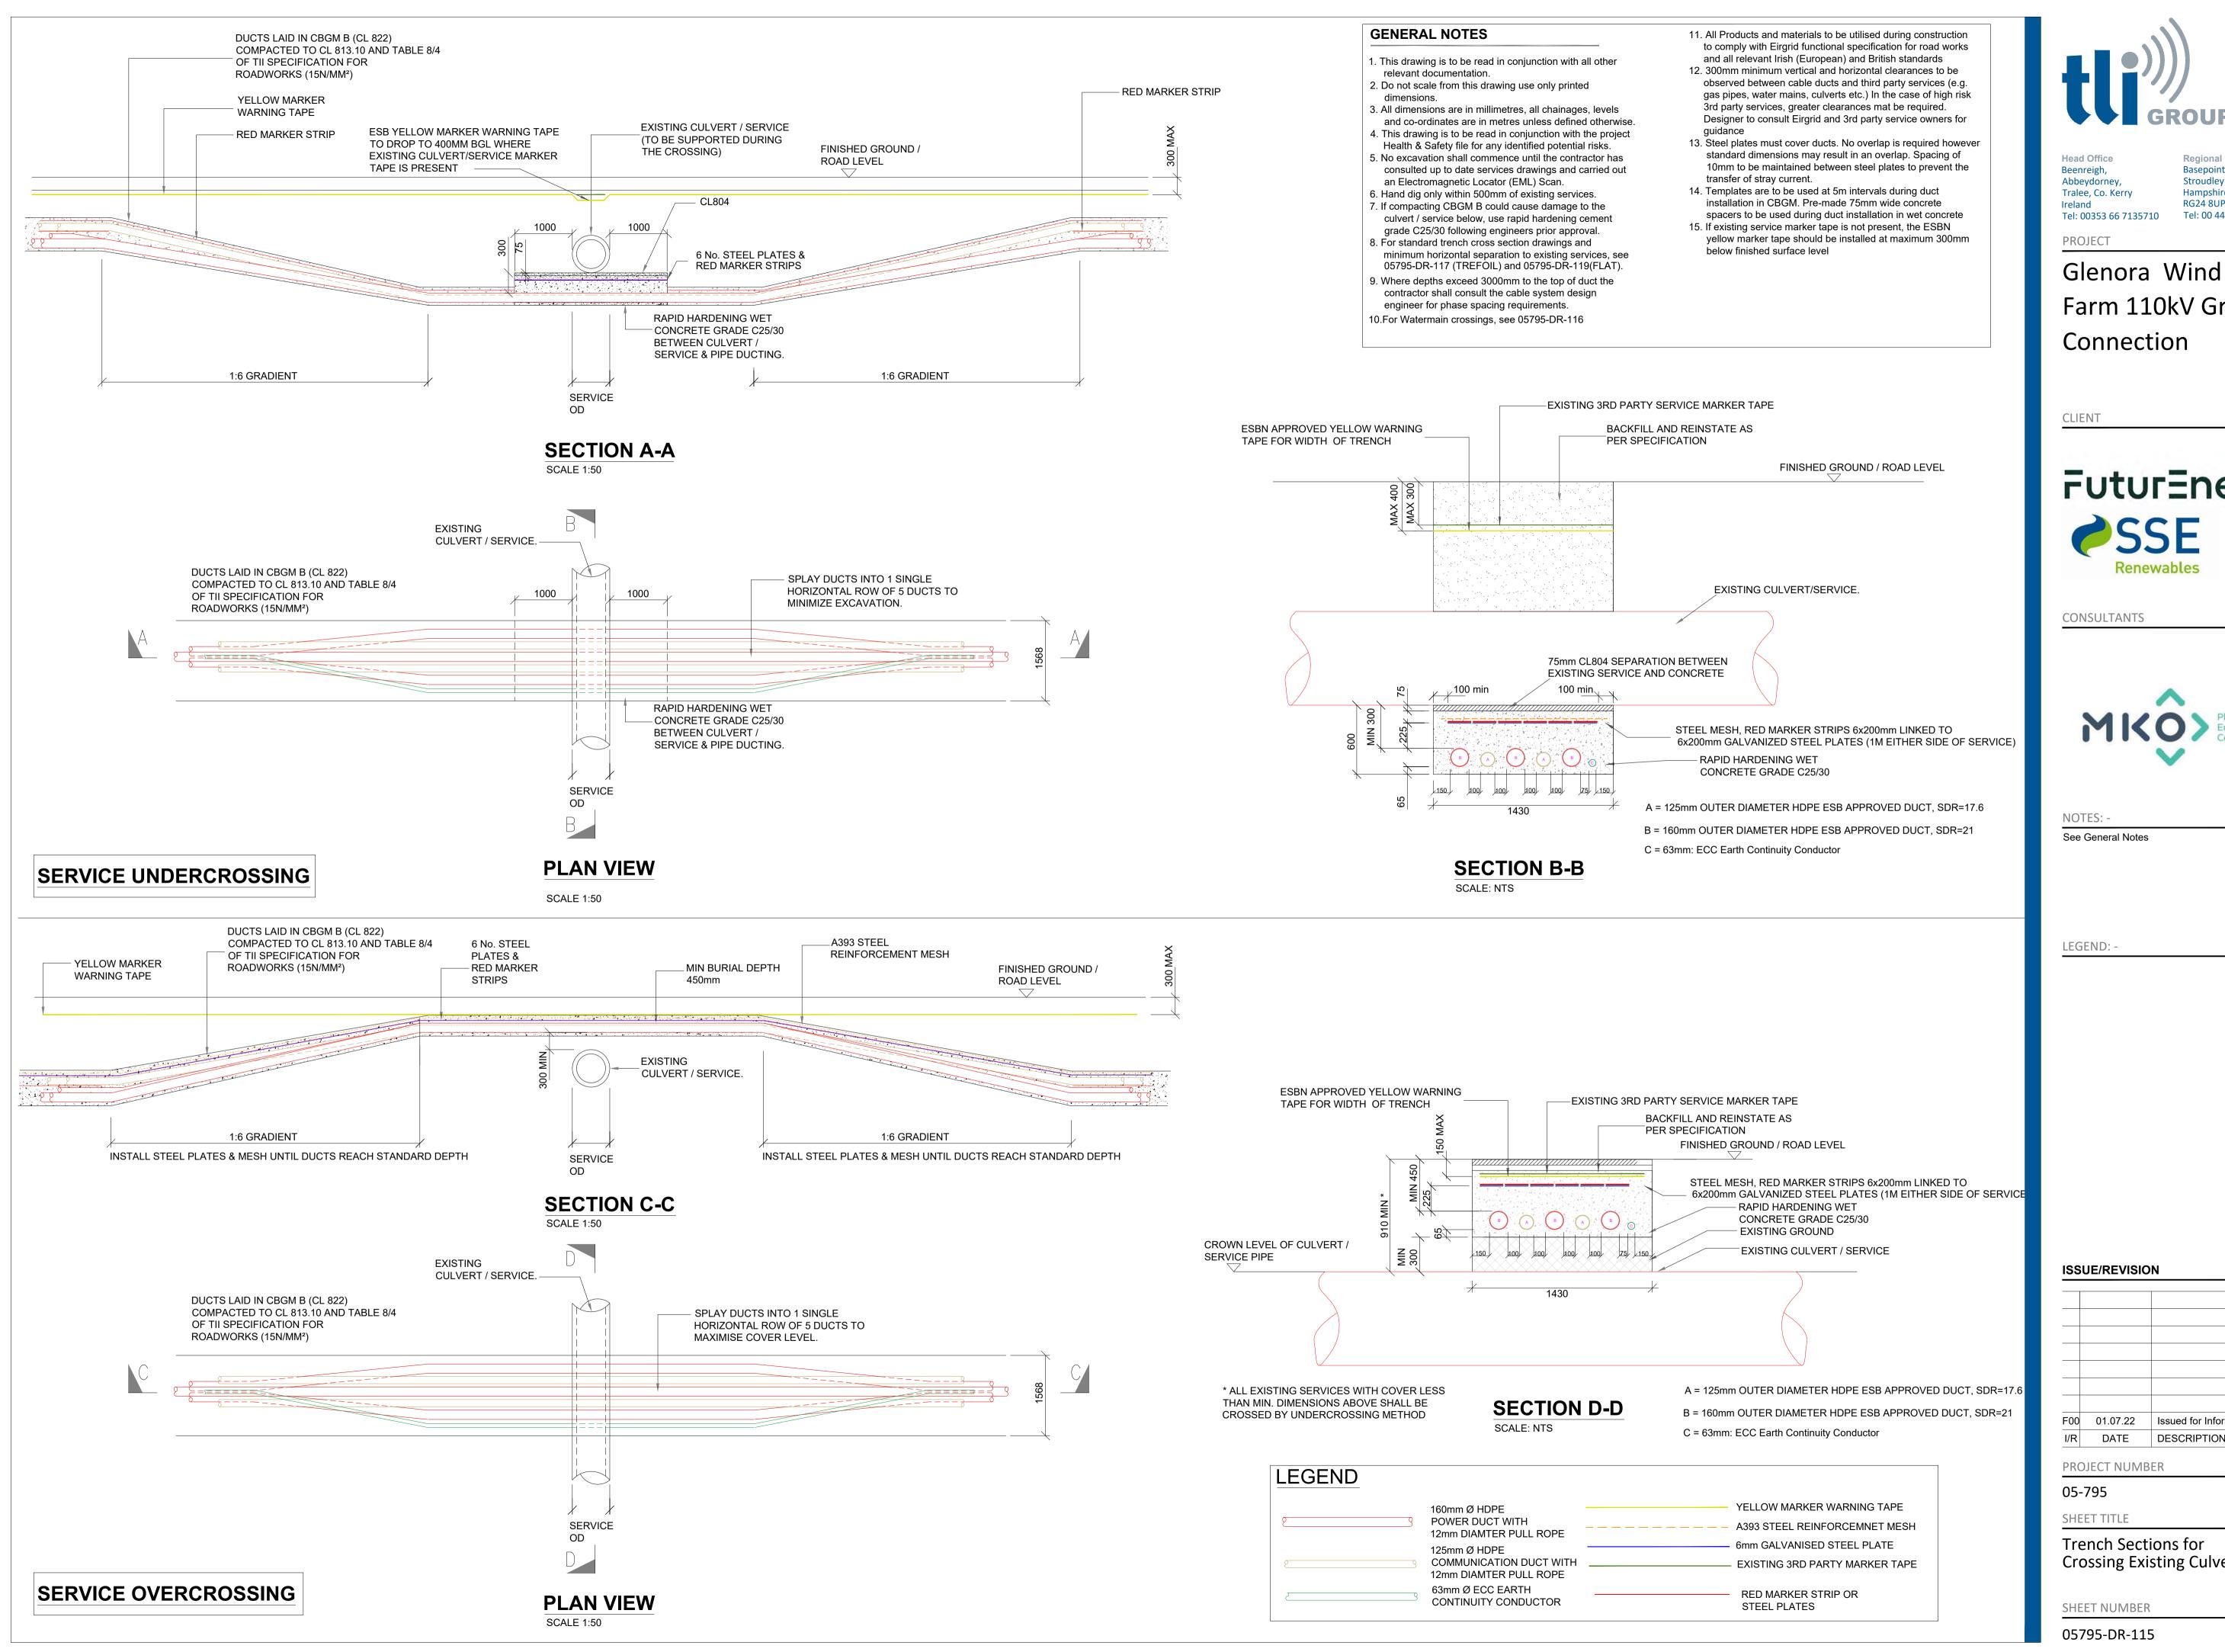

Regional Office **Basepoint Business Centre** Stroudley Road, Basingstoke, Hampshire, RG24 8UP, UK Tel: 00 44 1256406664


Farm 110kV Grid





F00 01.07.22 Issued for Information DESCRIPTION

Crossing Existing Culverts/Services

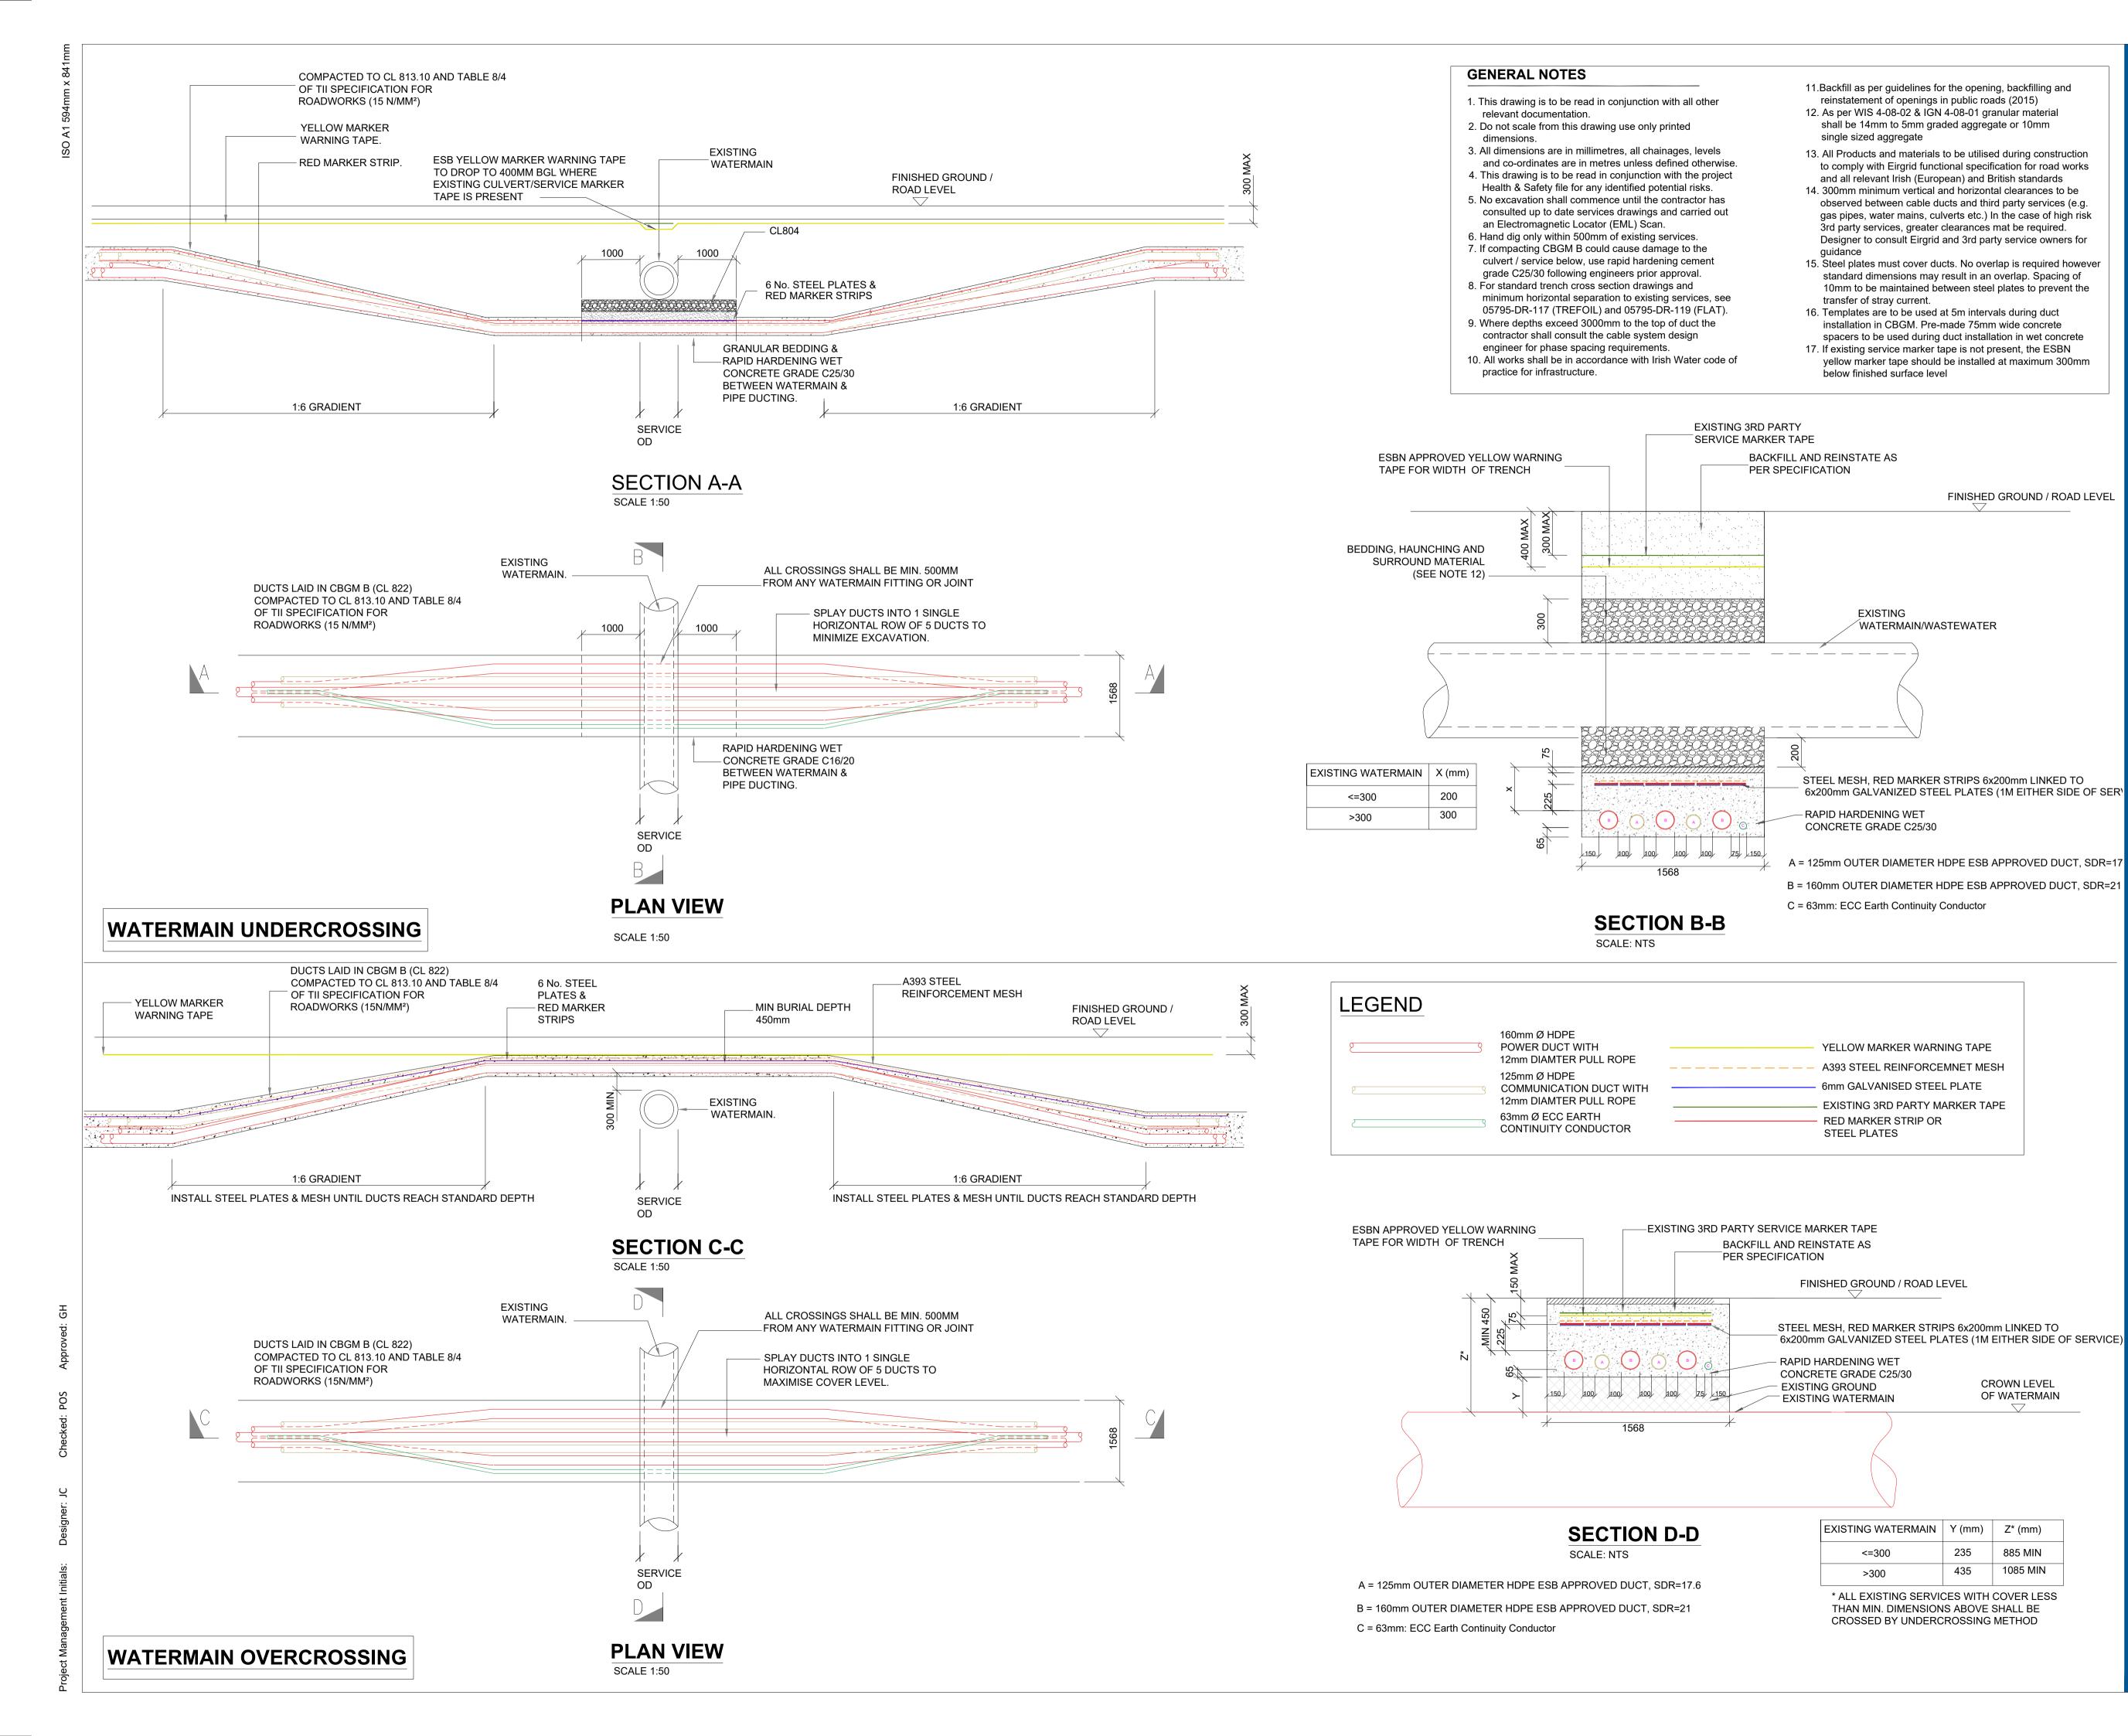

Head Office Beenreigh, Abbeydorney, Tralee, Co. Kerry Tel: 00353 66 7135710

Regional Office Basepoint Business Centre Stroudley Road, Basingstoke, RG24 8UP, UK Tel: 00 44 1256406664

Glenora Wind Farm 110kV Grid Connection

CLIENT



CONSULTANTS




NOTES: -

See General Notes

LEGEND: -

ISSUE/REVISION

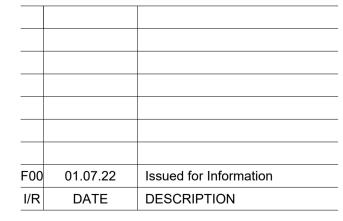

PROJECT NUMBER

05-795

SHEET TITLE

Trench Sections for Crossing Watermain/Wastewater


SHEET NUMBER

A = 125mm: Outer Diameter HDPE ESB Approved Duct, SDR=17.6 B= 160mm : Outer Diameter HDPE ESB Approved Duct, SDR= 21 C = 63mm: ECC Earth Continuity Conductor

Section Through Permanent Reinstatement of Longitudinal Opening in Roadway

SCALE 1:10

Reinstatement details based on Guidelines for Managing Openings in Public Roads - SD5

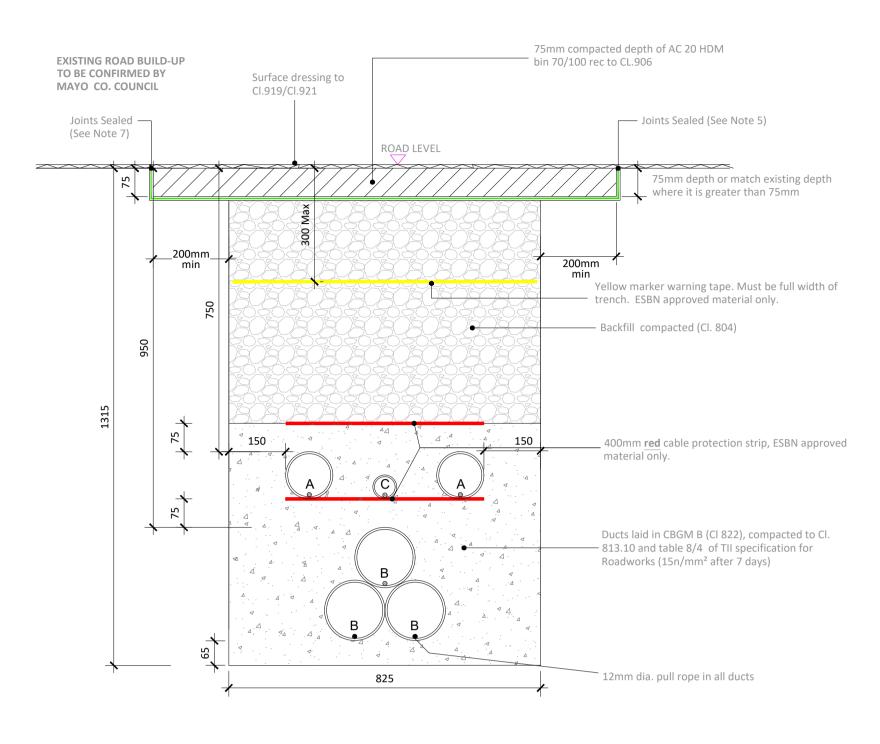

A = 125mm: Outer Diameter HDPE ESB Approved Duct, SDR=17.6 B= 160mm : Outer Diameter HDPE ESB Approved Duct, SDR= 21 C = 63mm: ECC Earth Continuity Conductor

Section Through Permanent Reinstatement of Longitudinal Opening in **Dressed Rural Unbound Roadway**

SCALE 1:10

ALL REINSTATEMENT WORKS ARE TO BE IN **ACCORDANCE WITH LOCAL AREA ENGINEERS** REQUIREMENTS AND GUIDELINES FOR MANAGING **OPENINGS IN PUBLIC ROADS**

- 1. Refer to Guidelines for managing Openings in Public Roads (Purple Book April 2017), Chapter 6 'Specifications' for guidance on Duct type / colour and Marker Tape type / colour.
- 2. All bound edges shall be saw cut to expose the full vertical thickness of each layer prior to excavation. All edges shall be essentially straight, smooth and vertical.
- 3. Where a temporary surface has been used, material shall be planed out to the depth specified in this drawing. The new permanent surface shall be machined laid and mechanically compacted with
- 4. Where the trimmed edge of excavation is within 400mm* of a joint / edge, ironwork or other reinstatement, this trimmed edge shall be extended to include same and the area of reinstatement shall be extended accordingly (* increase to 800mm where this is pre-existing practice).
- 5. Any damaged area adjacent to the opening and resulting from the excavation operation shall be included within the area to be reinstated.
- 6. Clause 808 or Cement Bound Granular Material surface to be sprayed per clause 920 prior to application of Asphalt Concrete Layer.
- 7. Joint sealer shall be a hot 50 pen bitumen binder or cold thixtropic bitumen 50 -70 pen to be applied to all vertical cuts in accordance with B.S.594987 prior to application of bituminous materials.
- 8. For roads without asphalt concrete surface (e.g. may be Cl.804 with double surface dressing), the road authority may as its discretion permit the temporary reinstatement surface of asphalt concrete to be regulated in lieu of excavation and reinstatement; and subsequently surface dressed.
- 9. On highly trafficked roads services must have a minimum cover of 750mm.
- 10. Where required by the Road authority the trench may be reinstated with a Cement Bound Granular

CLIENT

Head Office

Abbeydorney

PROJECT

Tralee, Co. Kerry

Tel: 00353 66 7135710

Glenora Wind

Connection

Farm 110kV Grid

Beenreigh,



Regional Office

RG24 8UP, UK

Tel: 00 44 1256406664

Hampshire,

Basepoint Business Centre

Stroudley Road, Basingstoke,

CONSULTANTS




- This drawing is to be read in conjunction with relevant
- drawings, specifications and reports Dimensions are in millimeters, unless noted otherwise
- Drawings are not to be scaled use figured dimensions only
- Geogrid may be implemented along the cable trench route where deemed necessary by the contractor or as required by Mayo County Council

LEGEND: -

Temporary Reinstatement

Reinstatement details based on Guidelines for Managing Openings in Public Roads - SD1

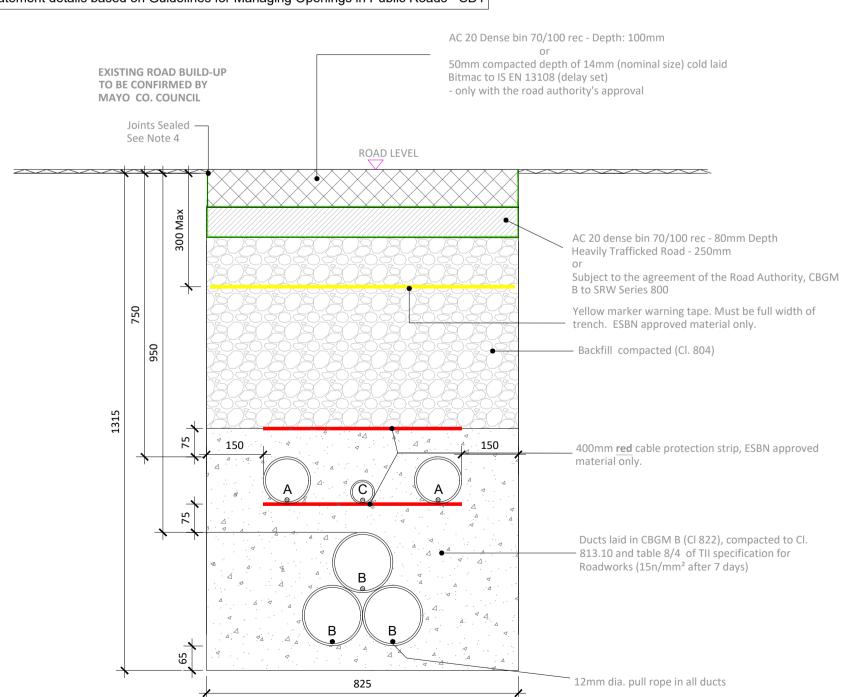


B= 160mm : Outer Diameter HDPE ESB Approved Duct, SDR= 21 C = 63mm: ECC Earth Continuity Conductor Section Through Temporary Reinstatement of Longitudinal Opening in

A = 125mm: Outer Diameter HDPE ESB Approved Duct, SDR=17.6

SCALE 1:10

Roadway

Reinstatement details based on Guidelines for Managing Openings in Public Roads - SD2

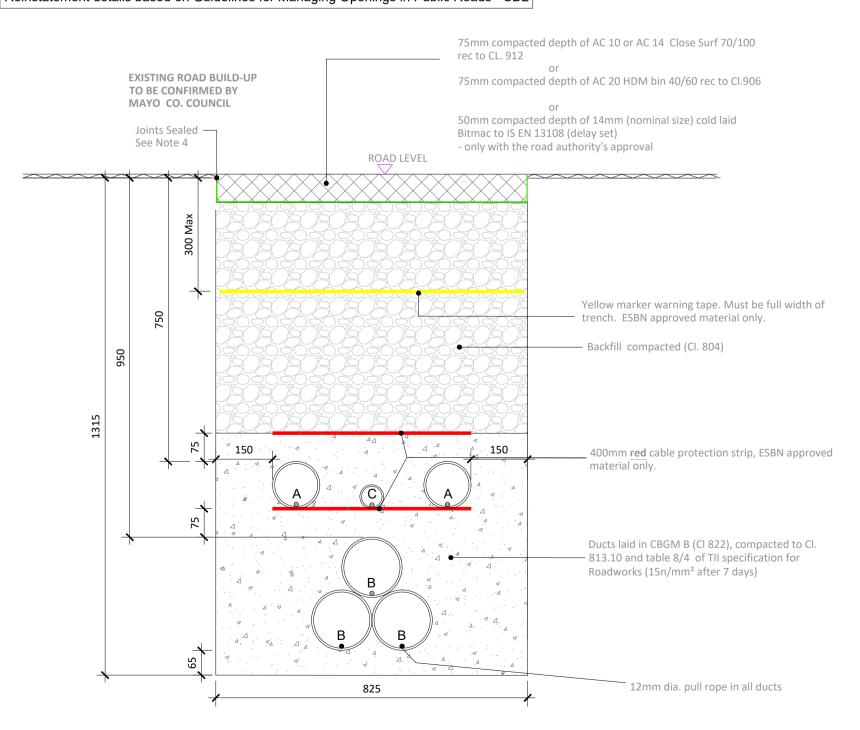

A = 125mm: Outer Diameter HDPE ESB Approved Duct, SDR=17.6 B= 160mm : Outer Diameter HDPE ESB Approved Duct, SDR= 21 C = 63mm: ECC Earth Continuity Conductor

Section Through Temporary Reinstatement of Longitudinal Opening in **Dressed Rural Unbound Roadway**

SCALE 1:10

ALL REINSTATEMENT WORKS ARE TO BE IN **ACCORDANCE WITH LOCAL AREA ENGINEERS** REQUIREMENTS AND GUIDELINES FOR MANAGING **OPENINGS IN PUBLIC ROADS**

1. Refer to 'Guidelines for managing Openings in Public Roads (Purple Book - April 2017)', Chapter 6 'Specifications' for guidance on Duct type / colour and Marker Tape type / colour.

- 2. All bound edges shall be saw cut to expose the full vertical thickness of each layer prior to excavation. All edges shall be essentially straight, smooth and vertical.
- 3. Clause 808 surface to be sprayed per clause 920 prior to application of Asphalt Concrete Layer.
- 4. Joint sealer shall be a hot 50 pen bitumen binder or cold thixotropic bitumen 50-70 pen to be applied to all vertical cuts in accordance with B.S. 594987 prior to application of bituminous
- 5. Licence holder must maintain temporary reinstatement to a safe and acceptable standard.
- 6. Any damaged area adjacent to the opening and resulting from the excavation operation shall be included within the area to be reinstated.
- 7. Temporary Road Surface warning signs must be used in accordance with the Traffic Signs Manual (Chaper 8 - Temporary Traffic Measures and Signs for Roadworks).
- 8. Refer to detail Permanent Reinstatement of Road for advice on permanent reinstatement all permanent reinstatement shall be carried out when adequate settlement has occurred as determined by the Road Authority.

ISSUE/REVISION

FC	00	01.07.22	Issued for Information
1/1	R	DATE	DESCRIPTION


PROJECT NUMBER

05-795

SHEET TITLE

Ducting Through Roadways

SHEET NUMBER

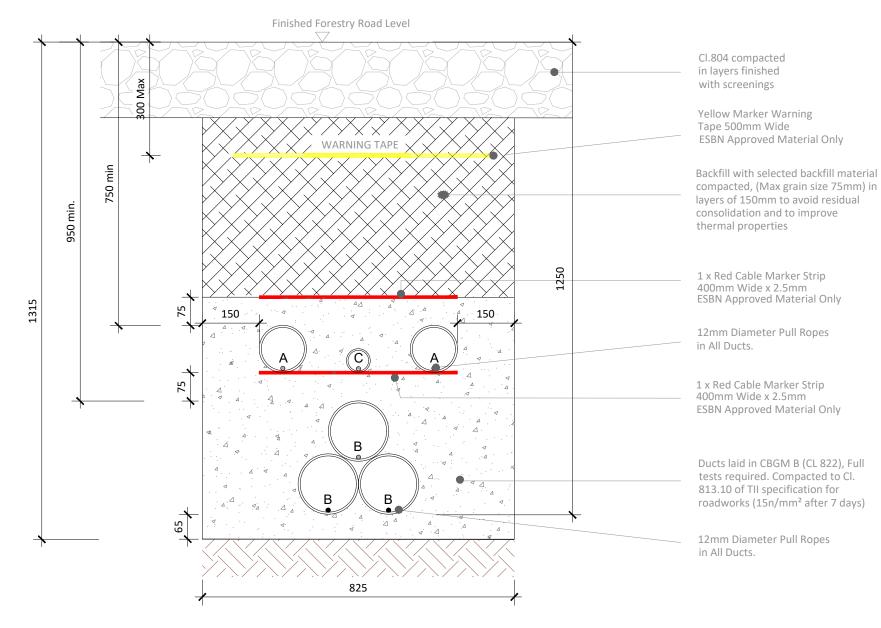

A = 125mm: Outer Diameter HDPE ESB Approved Duct, SDR=17.6 B= 160mm: Outer Diameter HDPE ESB Approved Duct, SDR= 21 C = 63mm: ECC Earth Continuity Conductor

Section Through Forestry Road

SCALE 1:10

ALL REINSTATEMENT WORKS ARE TO BE IN ACCORDANCE WITH LANDOWNERS REQUIREMENTS

Note:

- This drawing is to be read in conjunction with relevant drawings, specifications and reports
- Dimensions are in millimeters, unless noted otherwise
- Drawings are not to be scaled use figured dimensions only



Head Office Beenreigh, Abbeydorney, Tralee, Co. Kerry Ireland Tel: 00353 66 7135710 CLIENT



PROJECT

Glenora Wind Farm 110 kV Grid Connection


PROJECT NUMBER 05-795

SHEET NUMBER 05795-DR-118

SHEET TITLE

Ducting through Forestry Road

ISSU	E/REVISION	
F00	01.07.22	Issued for Information
I/R	DATE	DESCRIPTION

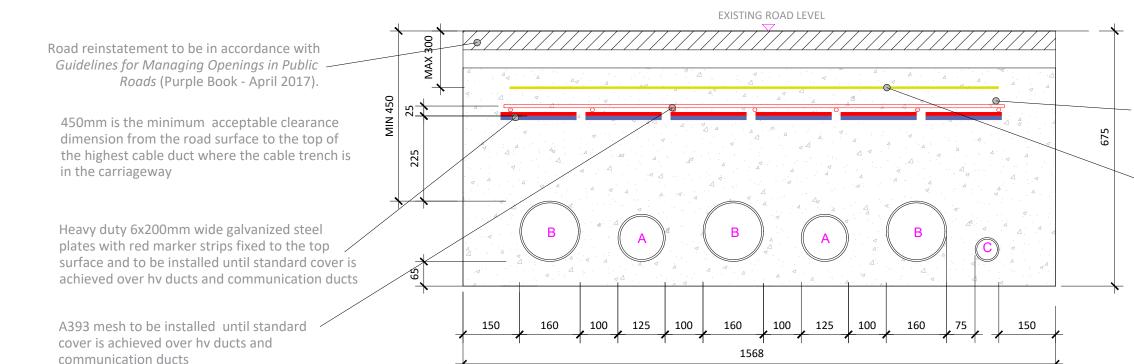

C25/30 concrete to be in accordance with specification for road works 1000. 20mm max size of aggregate, with minimum duct spacing of 75mm. Min. cover to steel - 50mm.

4 X 400mm ESBN yellow warning tape across full width of trench

A = 125mm: Outer Diameter HDPE ESB Approved Duct, SDR=17.6

B= 160mm : Outer Diameter HDPE ESB Approved Duct, SDR=21

C = 63mm: ECC Earth Continuity Conductor

Section Through Ducting in Flat Formation

SCALE 1:10

Note:

- This drawing is to be read in conjunction with relevant drawings, specifications and reports
- Dimensions are in millimeters, unless noted otherwise
- Drawings are not to be scaled use figured dimensions only

ALL REINSTATEMENT WORKS ARE TO BE IN ACCORDANCE WITH LOCAL AREA ENGINEERS
LANDOWNERS REQUIREMENTS AND GUIDELINES FOR MANAGING OPENINGS IN PUBLIC ROADS



Head Office Beenreigh, Abbeydorney, Tralee, Co. Kerry Ireland Tel: 00353 66 7135710 CLIENT



PROJECT

Glenora Wind Farm 110 kV Grid Connection

PROJECT NUMBER 05-795

SHEET NUMBER **05795-DR-119**

SHEET TITLE
Section Through Ducting

in Flat Formation

DRAWING STATUS

For Information

ISSUE/REVISION		
F00	01.07.22	Issued for Information
I/R	DATE	DESCRIPTION

110kV Grid Connection

SHEET NUMBER

05795-DR-231

PROJECT NUMBER

05-795

Futur=nergy

Beenreigh,

Ireland

Abbeydorney, Tralee, Co. Kerry

Tel: 00353 66 7135710

Bridge 1 - Proposed HDD Crossing

F00

I/R

01.07.22

DATE


Issued for Information

DESCRIPTION

DRAWING STATUS

For Information



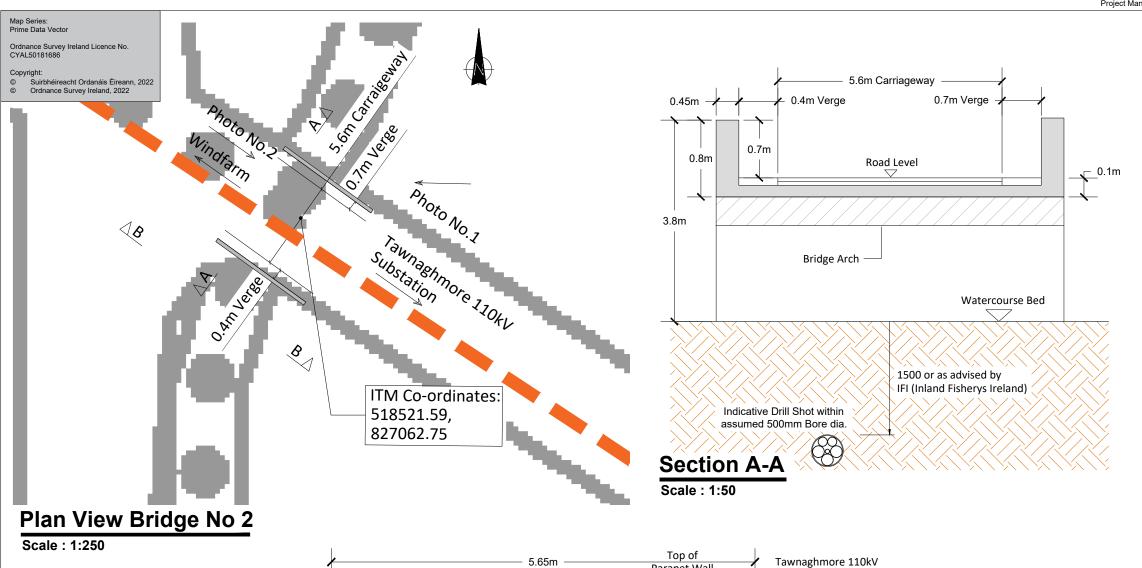

0.8m

2.5m

Directional Drilling Path/Cable Trench



Photo No. 1



Photo No. 2

NOTES:

- All dimensions are shown in meters unless otherwise stated.
- No structural bridge surveys have been carried out and the proposals are subject to detail design.
- Drawings are in compliance with ESBN specification requirements for shallow formation, bridge crossings, etc.



Head Office
Beenreigh,
Abbeydorney,
Tralee, Co. Kerry
Ireland
Tel: 00353 66 7135710

Windfarm

CLIENT



PROJECT

_0.1m=

0.4m

Glenora Wind Farm 110kV Grid Connection

Parapet Wall

PROJECT NUMBER 05-795

SHEET NUMBER
05795-DR-232

Substation


Road Level

Bridge 2 - Proposed HDD Crossing

DRAWING STATUS
For Information

SHEET TITLE

ISSU	ISSUE/REVISION		
F01	26.10.23	Issued for Information	
F00	01.07.22	Issued for Information	
I/R	DATE	DESCRIPTION	

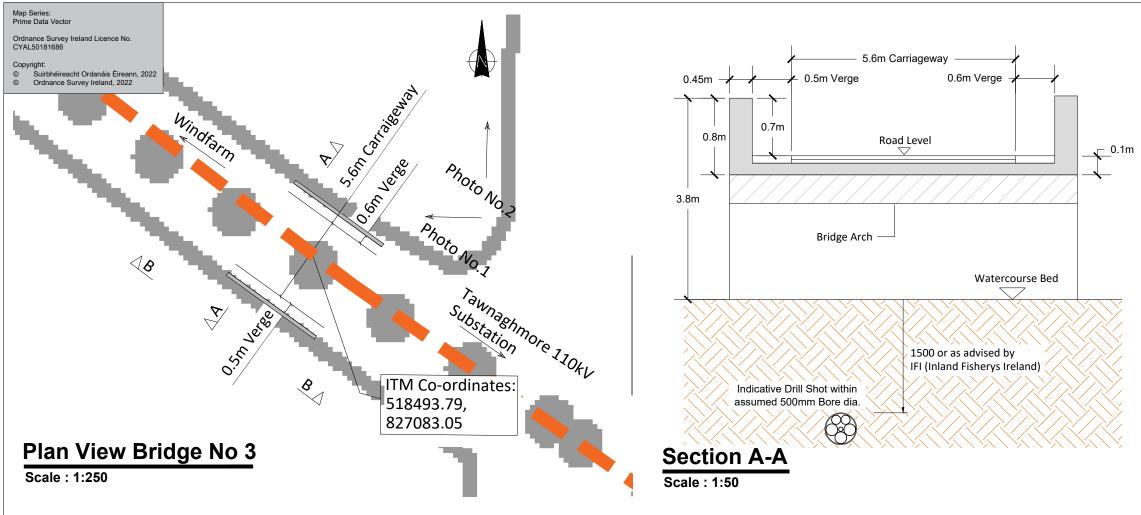

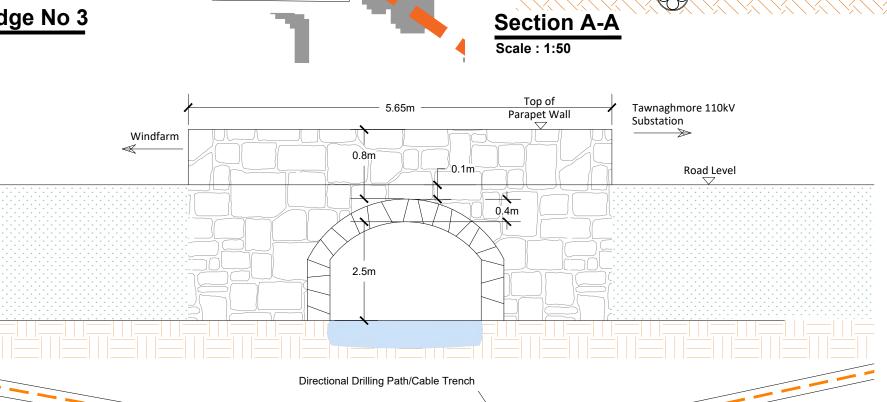




Photo No. 1



Photo No. 2

NOTES:

- All dimensions are shown in meters unless otherwise stated.
- No structural bridge surveys have been carried out and the proposals are subject to detail design.
- Drawings are in compliance with ESBN specification requirements for shallow formation, bridge crossings, etc.
- HDD launch and reception pit locations to be determined following site investigation.



Section B-B

Scale 1:50

Head Office Beenreigh, Abbeydorney, Tralee, Co. Kerry Ireland Tel: 00353 66 7135710 Futur=nergy

CLIENT

PROJECT

Glenora Wind Farm 110kV Grid Connection

PROJECT NUMBER 05-795

SHEET NUMBER 05795-DR-233 SHEET TITLE

Bridge 3 - Proposed HDD Crossing

ISSU	ISSUE/REVISION		
F01	26.10.23	Issued for Information	
F00	01.07.22	Issued for Information	
I/R	DATE	DESCRIPTION	

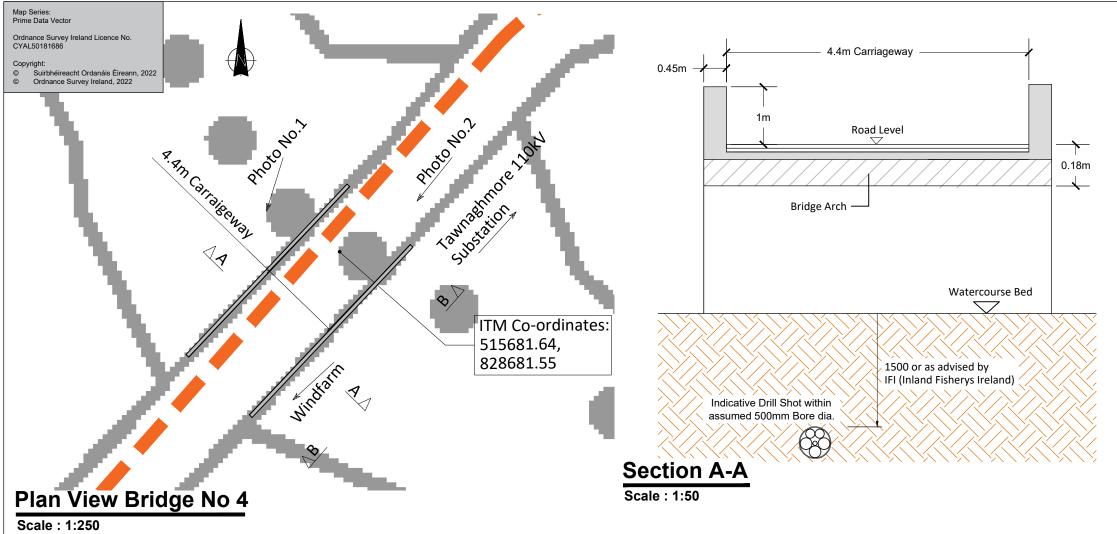




Photo No. 1



Photo No. 2

Windfarm Top of Parapet Wall O 33m O 18m O 35m O 25m O 28m O 4m O 32m O 22m Directional Drilling Path/Cable Trench

NOTES:

- All dimensions are shown in meters unless otherwise stated.
- No structural bridge surveys have been carried out and the proposals are subject to detail design.
- Drawings are in compliance with ESBN specification requirements for shallow formation, bridge crossings, etc.
- HDD launch and reception pit locations to be determined following site investigation.



Scale 1:50

Head Office
Beenreigh,
Abbeydorney,
Tralee, Co. Kerry
Ireland
Tel: 00353 66 7135710

CLIENT _____ |re

Futur=nergy
SSE

PROJECT

Glenora Wind Farm 110kV Grid Connection

PROJECT NUMBER 05-795


SHEET NUMBER 05795-DR-234 Duides 4 Due

SHEET TITLE

Tawnaghmore 110kV

Bridge 4 - Proposed HDD Crossing

ISSUI	ISSUE/REVISION		
F00	01.07.22	Issued for Information	
I/R	DATE	DESCRIPTION	

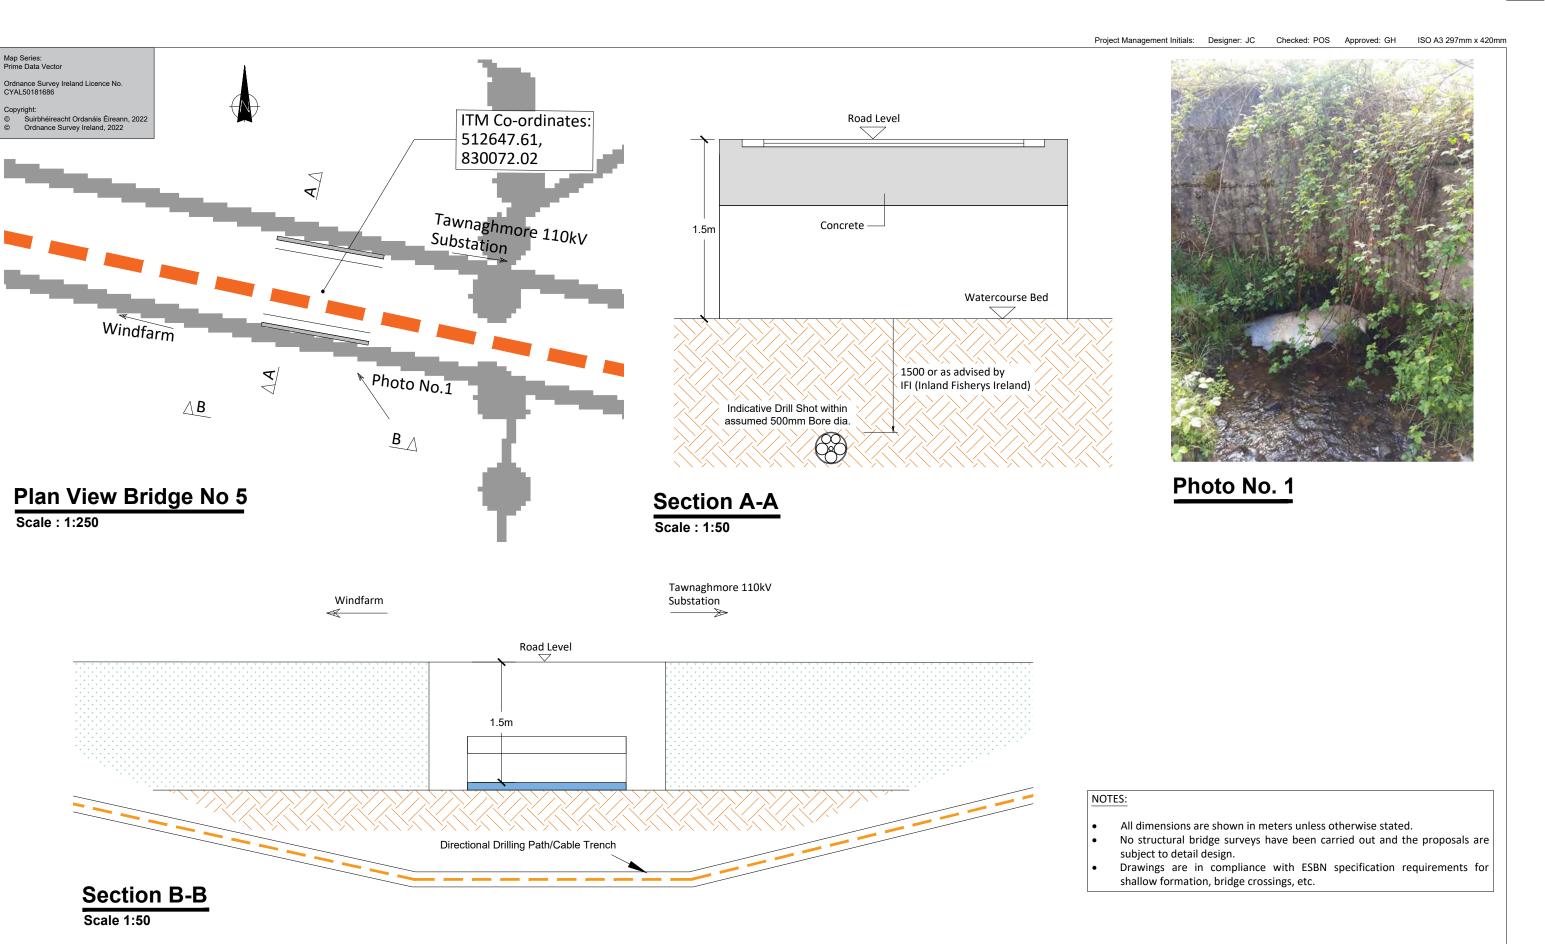



Head Office
Beenreigh,
Abbeydorney,
Tralee, Co. Kerry
Ireland
Tel: 00353 66 7135710

CLIENT

Futur=nergy

SSE

Renewables

PROJECT

Glenora Wind Farm 110kV Grid Connection


PROJECT NUMBER 05-795

SHEET NUMBER **05795-DR-235**

SHEET TITLE

Bridge 5 - Proposed Crossing

ISSUE/REVISION			
F00	01.07.22	Issued for Information	
I/R	DATE	DESCRIPTION	

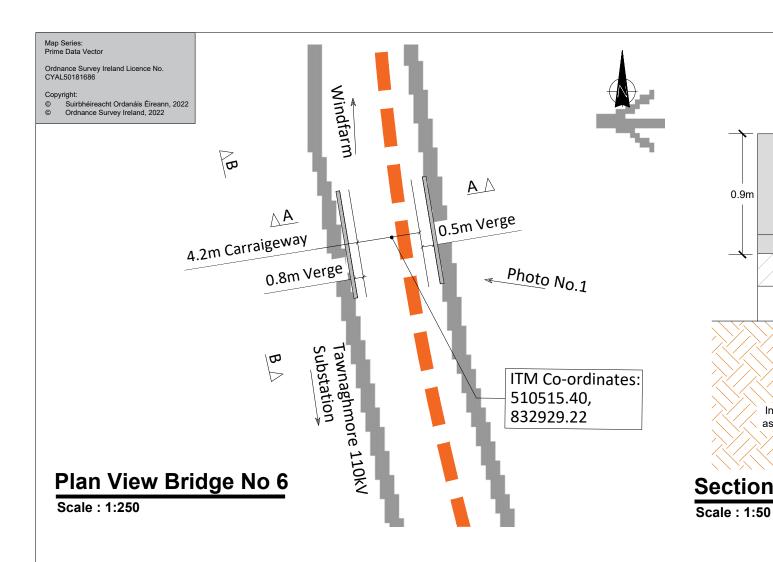


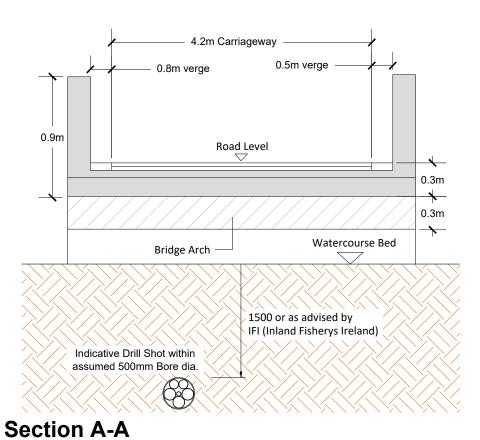




Photo No. 1

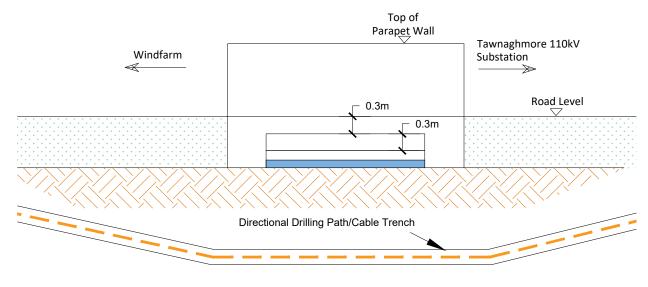

Scale 1:50

NOTES:

- All dimensions are shown in meters unless otherwise stated.
- No structural bridge surveys have been carried out and the proposals are subject to detail design.
- Drawings are in compliance with ESBN specification requirements for shallow formation, bridge crossings, etc.
- HDD launch and reception pit locations to be determined following site investigation.



Head Office
Beenreigh,
Abbeydorney,
Tralee, Co. Kerry
Ireland
Tel: 00353 66 7135710

Futur=nergy

CLIENT

PROJECT
Glenora Wind Farm

110kV Grid Connection

PROJECT NUMBER 05-795

SHEET NUMBER 05795-DR-236 SHEET TITLE

Bridge 6 - Proposed HDD Crossing

ISSU	ISSUE/REVISION		
F00	01.07.22	Issued for Information	
I/R	DATE	DESCRIPTION	

Head Office Beenreigh, Abbeydorney, Tralee, Co. Kerry Ireland Tel: 00353 66 7135710




PROJECT

Glenora Wind Farm 110kV Grid Connection

PROJECT NUMBER 05-795

SHEET NUMBER 05795-DR-237 SHEET TITLE

Bridge 7 - Proposed HDD Crossing

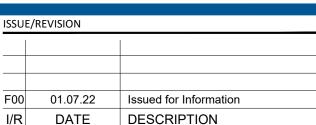

SHEET NUMBER

05795-DR-238

DRAWING STATUS

For Information

F00

I/R

01.07.22

DATE

Issued for Information


DESCRIPTION

PROJECT NUMBER

05-795

Ireland

Tel: 00353 66 7135710

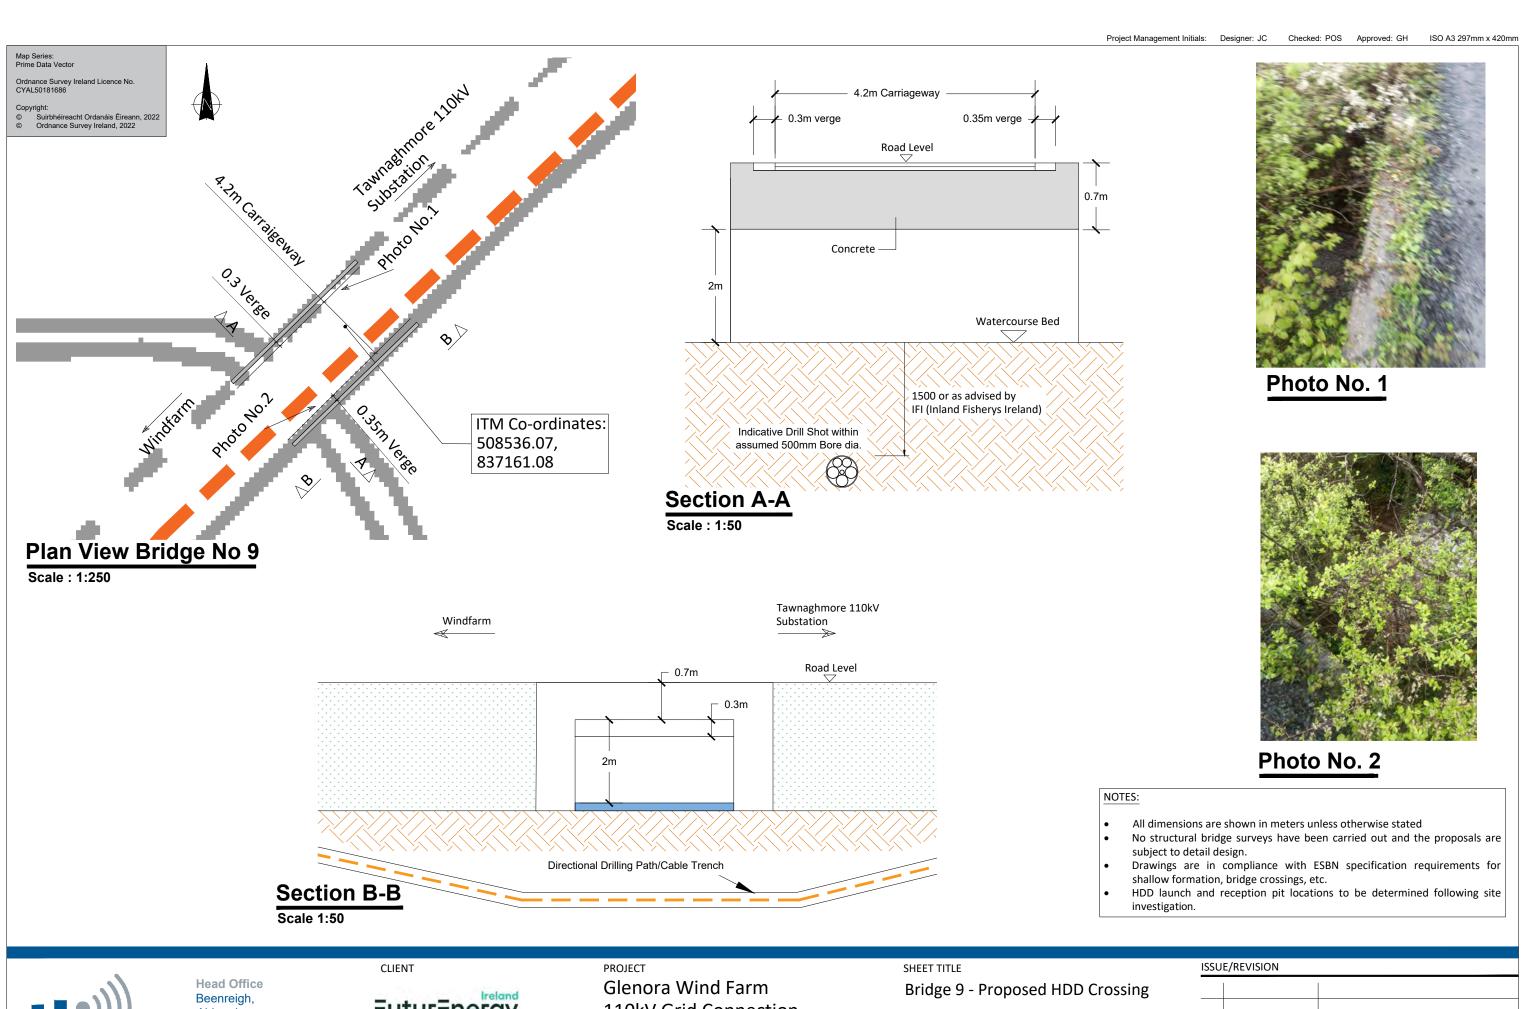



Abbeydorney, Tralee, Co. Kerry Ireland Tel: 00353 66 7135710 Futur=nergy

110kV Grid Connection

PROJECT NUMBER 05-795

SHEET NUMBER 05795-DR-239

DRAWING STATUS F00 01.07.22 Issued for Information For Information I/R DATE **DESCRIPTION**


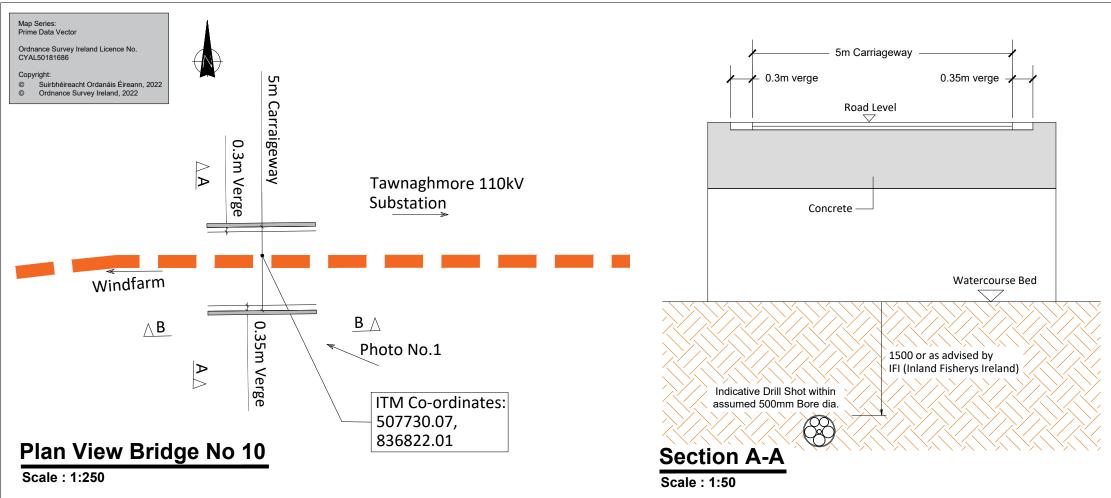




Photo No. 1

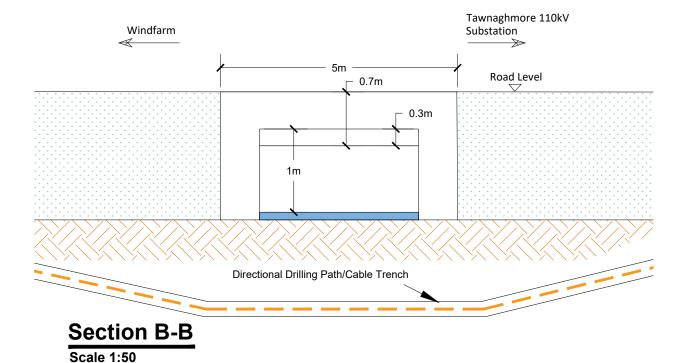

NOTES:

- All dimensions are shown in meters unless otherwise stated.
- No structural bridge surveys have been carried out and the proposals are subject to detail design.
- Drawings are in compliance with ESBN specification requirements for shallow formation, bridge crossings, etc.
- HDD launch and reception pit locations to be determined following site investigation.



Head Office
Beenreigh,
Abbeydorney,
Tralee, Co. Kerry
Ireland
Tel: 00353 66 7135710

CLIENT

Futur=nergy

SSE

Renewables

PROJECT


Glenora Wind Farm 110kV Grid Connection

PROJECT NUMBER 05-795

SHEET NUMBER 05795-DR-240 SHEET TITLE

Bridge 10 - Proposed HDD Crossing

ISSUI	ISSUE/REVISION			
F00	01.07.22	Issued for Information		
I/R	DATE	DESCRIPTION		

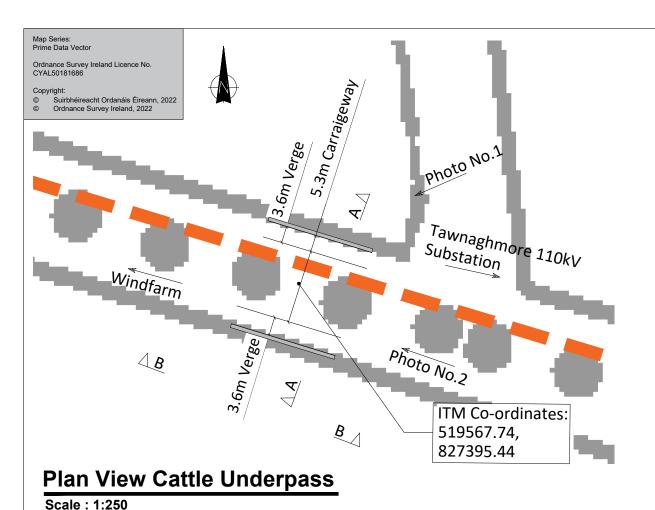

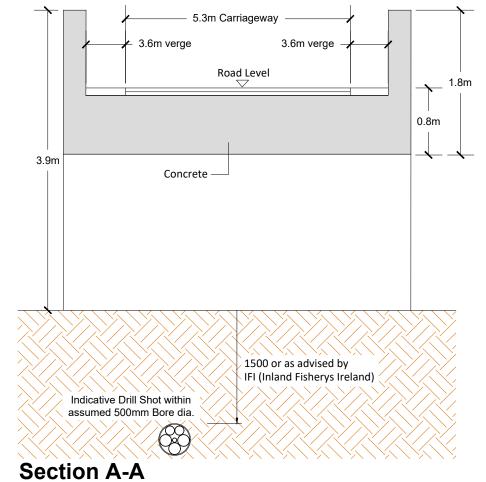




Photo No. 1



Photo No. 2

Scale 1:50



Windfarm

1.8m

0.3m



Head Office Beenreigh, Abbeydorney, Tralee, Co. Kerry Ireland Tel: 00353 66 7135710

Directional Drilling Path/Cable Trench

CLIENT

3.9m



PROJECT

Tawnaghmore 110kV

Substation

Road Level

Glenora Wind Farm 110kV Grid Connection

Scale: 1:50

PROJECT NUMBER 05-795


SHEET NUMBER 05795-DR-241 SHEET TITLE

Cattle underpass proposed **HDD** crossing DRAWING STATUS For Information

ISSU	ISSUE/REVISION				
F00	01.07.22	Issued for Information			
I/R	DATE	DESCRIPTION			

NOTES:

- All dimensions are shown in meters unless otherwise stated.
- No structural bridge surveys have been carried out and the proposals are subject to detail design.
- Drawings are in compliance with ESBN specification requirements for shallow formation, bridge crossings, etc.
- HDD launch and reception pit locations to be determined following site investigation.

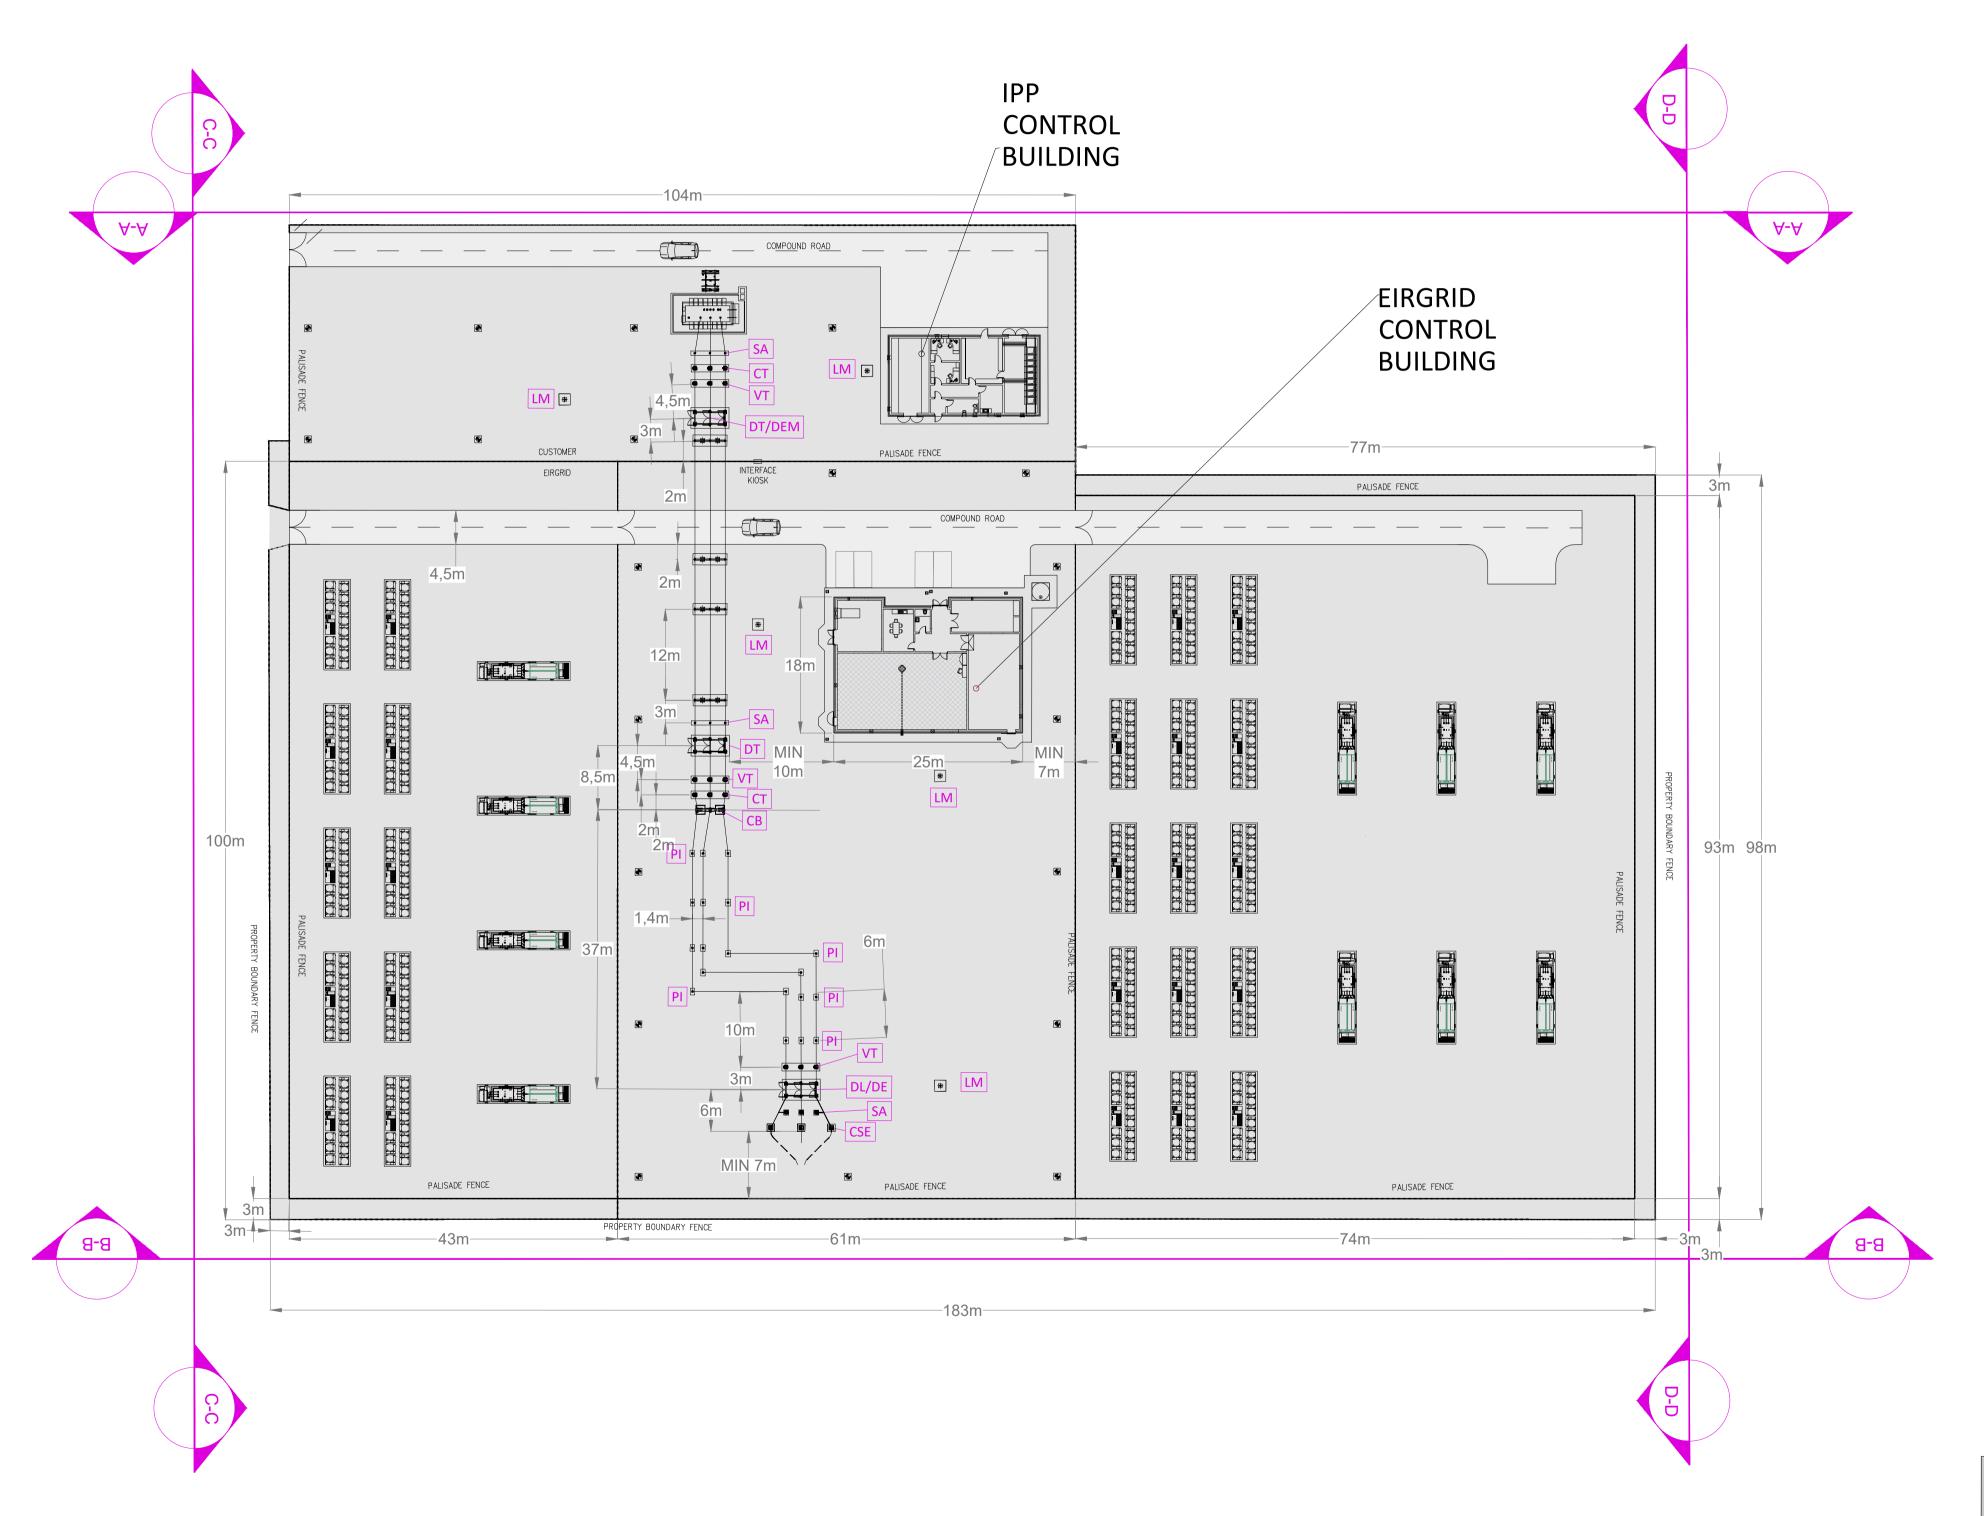

Description Surge Arrester. DL/DE Line / Earth Disconnect. DT Disconnect VT Voltage Transformer. CT Current Transformer.

Map Series: 1:5,000 Prime Data Raster

Ordnance Survey Ireland Licence No. EN 0073720

© Ordnance Survey Ireland, 2022

© Suirbhéireacht Ordanáis Éireann, 2022

Sheet Reference No.'s

OS2242_D

СВ Circuit Breaker. Post Insulator. LM Lighting Mast. LS Lamp Standard CSE Cable Sealing End

Drawing Notes:

Layout and Arrangements of Substation Building and Electrical Equipment is shown indicatively and for illustration purposes only.

2. Dimensions shown are as per current EirGrid Specifications at the time of submission. Dimensions may vary at time of construction to reflect any revisions to EirGrid Specifications.

3. Final Specifications of Buildings and Electrical Equipment is to be as per EirGrid and ESB Specifications.

4. The Elevation of the Compound will be depicted by localized Topography such that Cut/Fill Earthworks associated with the construction of the Compound are balanced.

5. An oil interceptor will be installed below ground, position TBC during detailed design.

Glenora Wind Farm 110kV Grid Connection

Regional Office Basepoint Business Centre Stroudley Road, Basingstoke,

Hampshire, RG24 8UP, UK Tel: 00 44 1256406664

CLIENT



CONSULTANTS



NOTES: -See General Notes

LEGEND: -

shown thus

Lamp Standard

UGC Grid Connection Route shown thus Required Infrastructure

Proposed Levels shown thus Permanent Paved Access Roads



279.10m

ISSUE/REVISION

F00	04.07.22	Issued for Information
I/R	DATE	DESCRIPTION

PROJECT NUMBER

05-795


SHEET TITLE

Substation Layout Plan

SHEET NUMBER


05795-DR-300

Substation Layout Plan

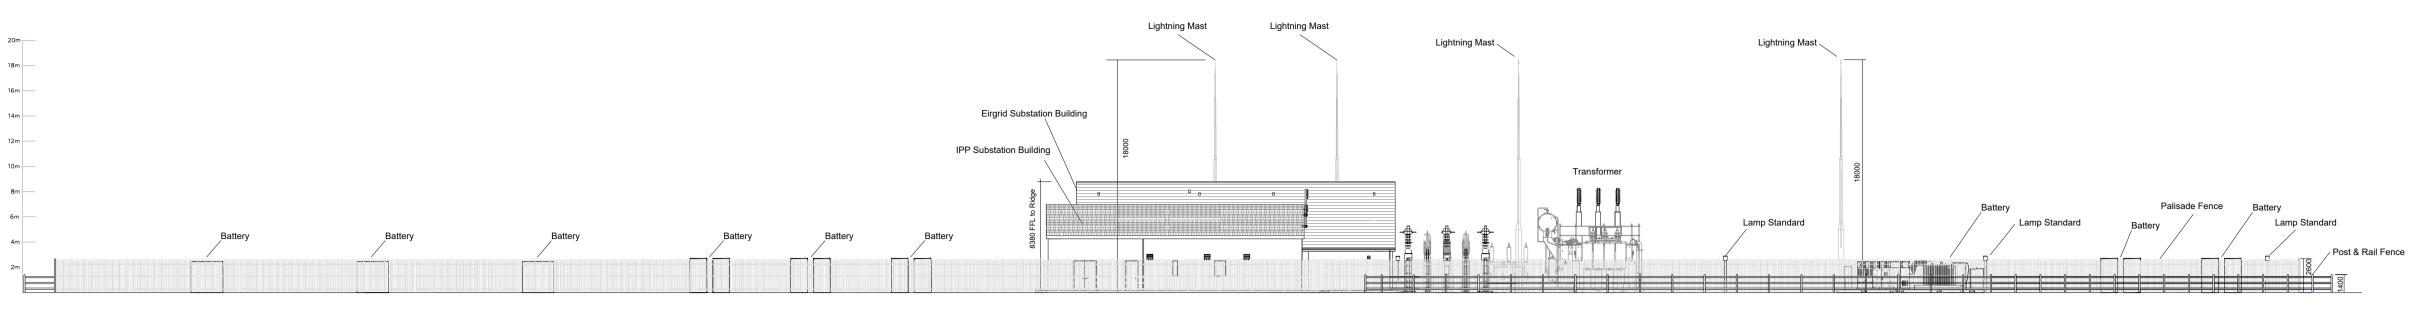


Section A-A Elevation

SCALE 1:200

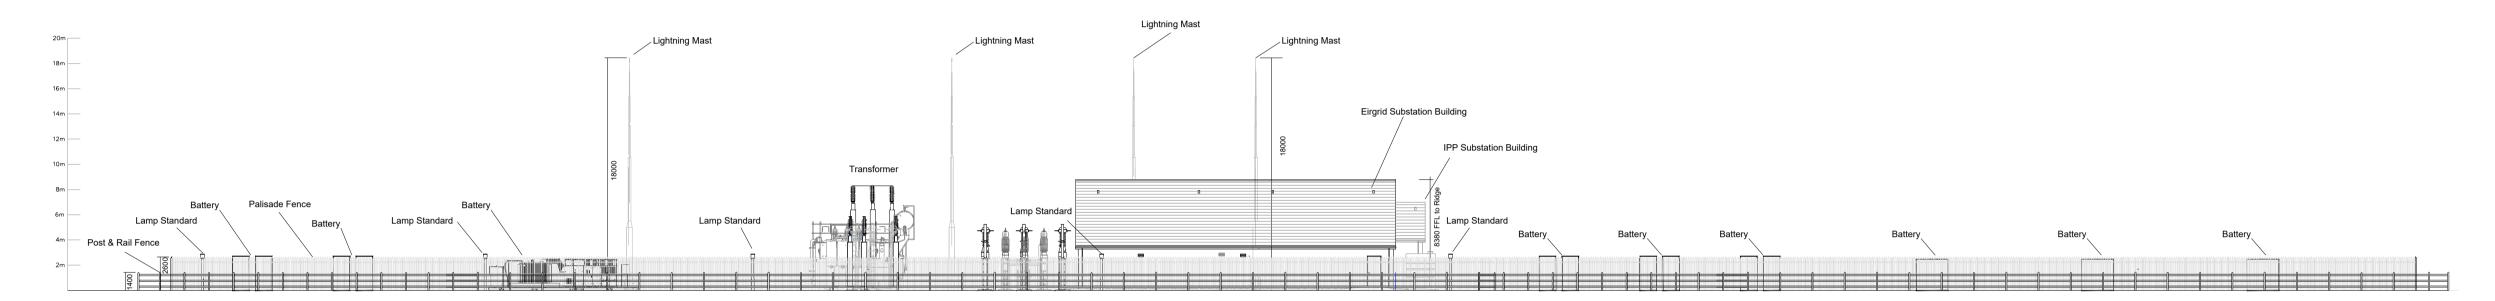


Section B-B Elevation

SCALE 1:200

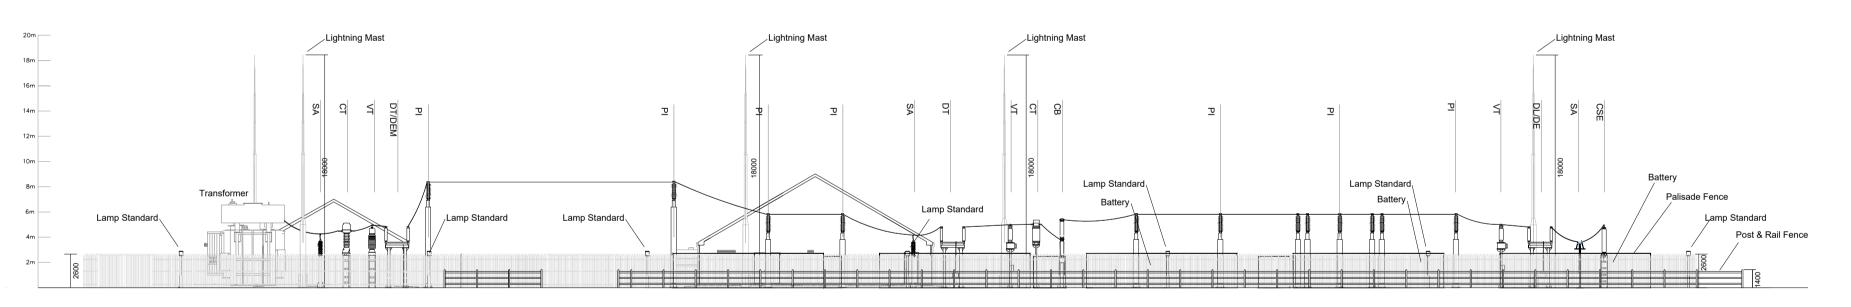

Section C-C Elevation

SCALE 1:200

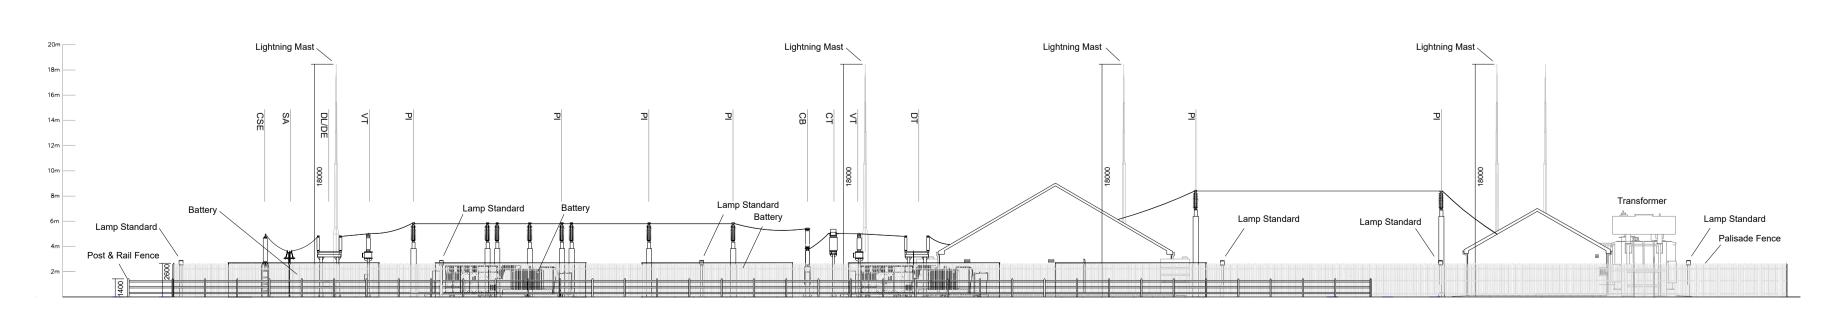

Section D-D Elevation

SCALE 1:200



Head Office Beenreigh, Abbeydorney, Tralee, Co. Ker Ireland Regional Office
Basepoint Business Centre
Stroudley Road, Basingstoke,
Hampshire,
RG24 8UP, UK
Tel: 00 44 1256406664

ROJECT

Glenora Wind Farm 110kV Grid Connection

CLIENT



CONSULTANTS



NOTES: -

- Layout and Arrangements of Substation Building and Electrical Equipment is shown indicatively and for illustration purposes only.
- Dimensions shown are as per current EirGrid Specifications at the time of submission. Dimensions may vary at time of construction to reflect any revisions to EirGrid Specifications.
- Final Specifications of Buildings and Electrical Equipment is to be as per Eirgrid and ESB Specifications.
- The Elevation of the Compound will be depicted by localized Topography such that Cut/Fill Earthworks associated with the construction of the Compound are balanced.

 I EGEND: -

	Description
SA	Surge Arrester.
DL/DE	Line / Earth Disconnect.
DT	Disconnect
VT	Voltage Transformer.
СТ	Current Transformer.
СВ	Circuit Breaker.
PI	Post Insulator.
LM	Lighting Mast.
LS	Lamp Standard
CSE	Cable Sealing End

F00	04.07.22	Issued for Information
I/R	DATE	DESCRIPTION


PROJECT NUMBER

05-795

SHEET TITLE

Substation Elevations

SHEET NUMBER

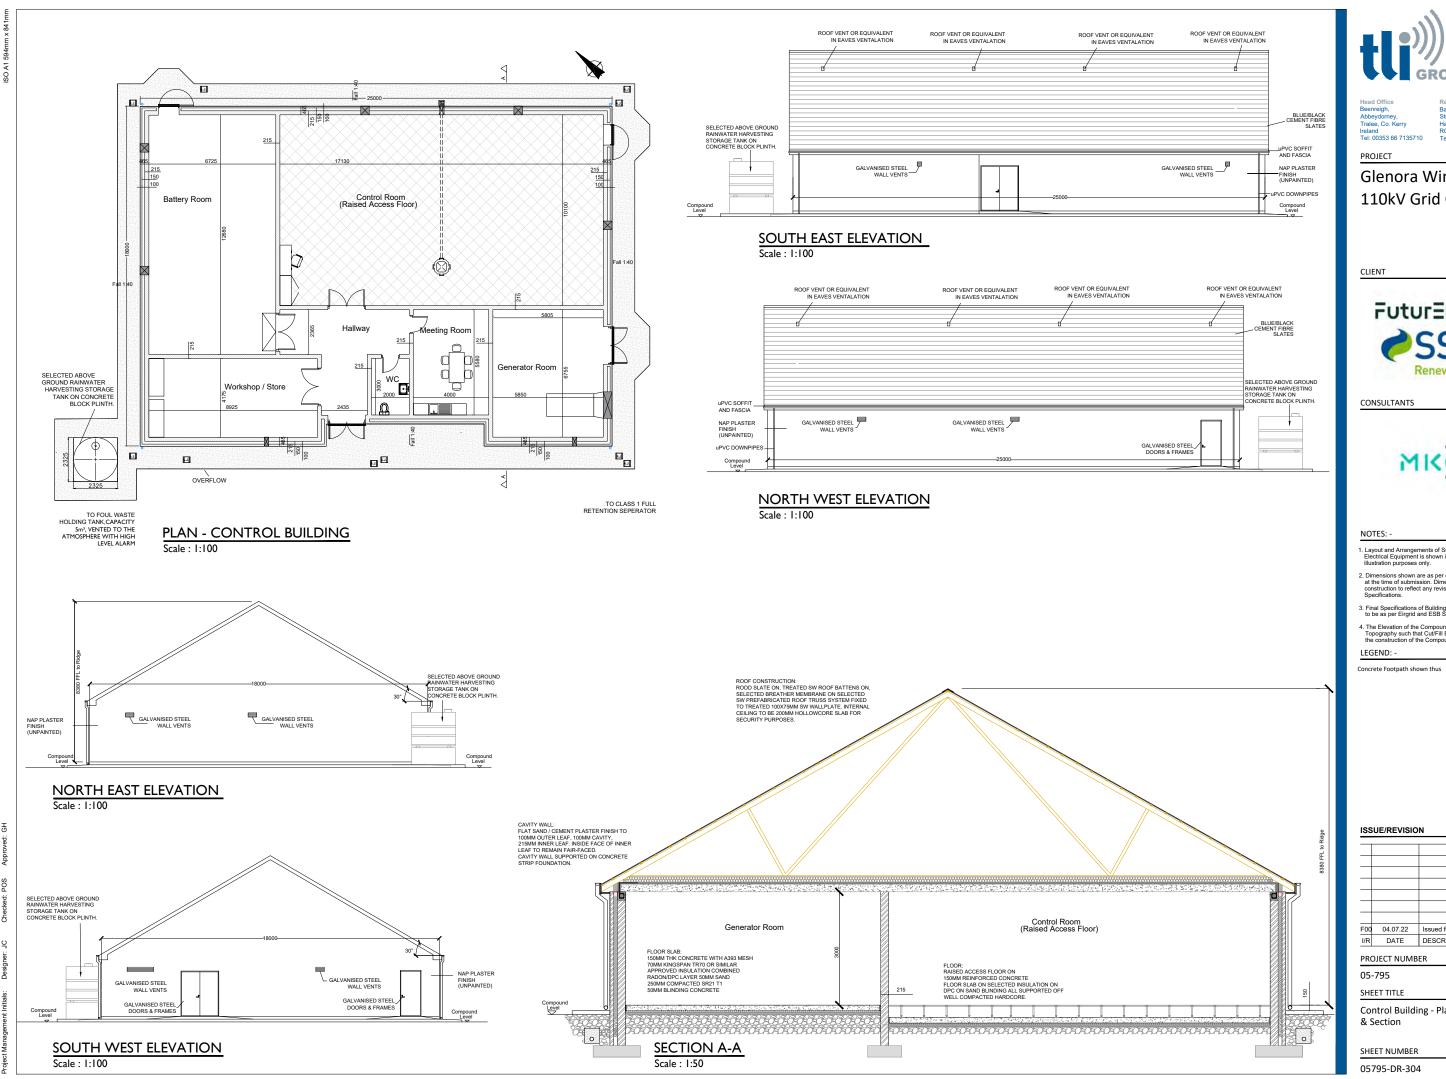


Basepoint Business Centre Stroudley Road, Basingstoke Hampshire, RG24 8UP, UK Tel: 00 44 1256406664

Glenora Wind Farm 110kV Grid Connection






- Layout and Arrangements of Substation Building and Electrical Equipment is shown indicatively and for illustration purposes only.
- Dimensions shown are as per current EirGrid Specifications at the time of submission. Dimensions may vary at time of construction to reflect any revisions to EirGrid Specifications.
- Final Specifications of Buildings and Electrical Equipment is to be as per Eirgrid and ESB Specifications.
- The Elevation of the Compound will be depicted by localizer
 Topography such that Cut/Fill Earthworks associated with
 the construction of the Compound are balanced.

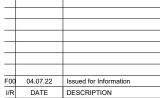


Control Building - Plan & Elevations

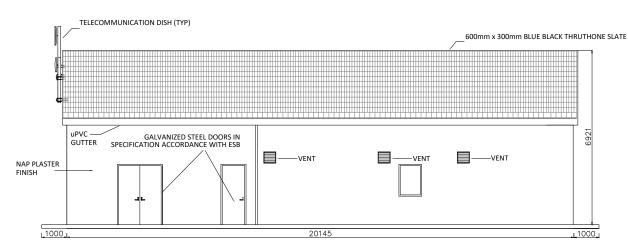


SOUTH EAST ELEVATION


Scale: 1:75

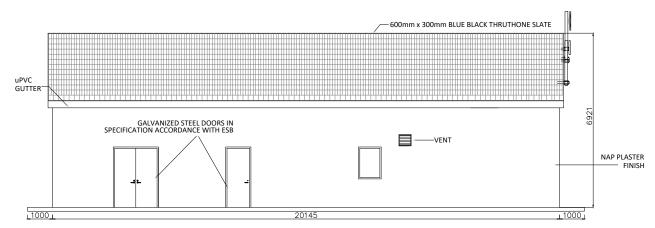

NORTH WEST ELEVATION


Scale: 1:75

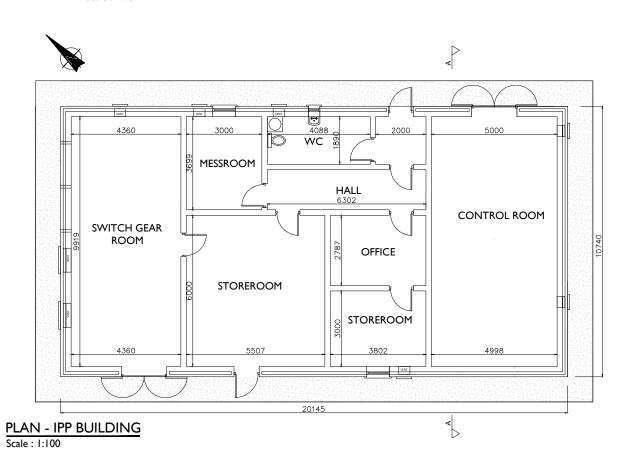

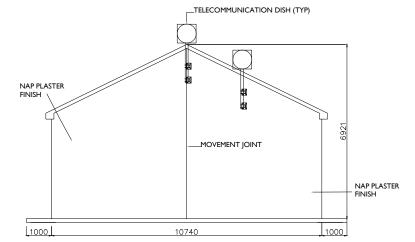


SOUTH WEST ELEVATION

Scale: 1:75

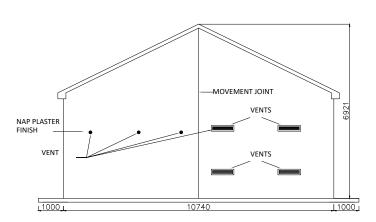

NORTH EAST ELEVATION

Scale: 1:75

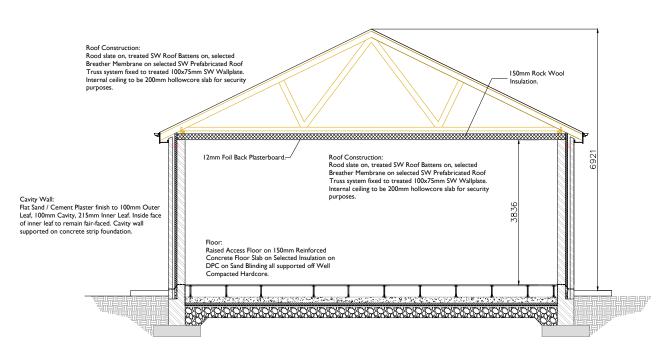

Scale: 1:50



Beenreigh,
Abbeydorney,
Tralee, Co. Kerl

Basepoint Business Centre Stroudley Road, Basingstoke Hampshire, RG24 8UP, UK Tel: 00 44 1256406664

PROJECT

Glenora Wind Farm 110kV Grid Connection

CLIENT



CONSULTANTS



NOTES: -

- Layout and Arrangements of Substation Building and Electrical Equipment is shown indicatively and for illustration purposes only.
- Dimensions shown are as per current EirGrid Specifications at the time of submission. Dimensions may vary at time of construction to reflect any revisions to EirGrid Specifications.
- Final Specifications of Buildings and Electrical Equipment is to be as per Eirgrid and ESB Specifications.
- The Elevation of the Compound will be depicted by localized Topography such that Cut/Fill Earthworks associated with the construction of the Compound are balanced.

LEGEND: -

Concrete Footpath shown thus

ISSUE/REVISION

F00	04.07.22	Issued for Information
I/R	DATE	DESCRIPTION

PROJECT NUMBER

05-795

SHEET TITLE

IPP Building - Plan & Elevations & Section

SHEET NUMBER